

DRAWINGS


CHESTERFIELD UPPER (EAST) POND COAL COMBUSTION RESIDUALS (CCR) CLOSURE PLAN

CHESTERFIELD POWER STATION CHESTERFIELD COUNTY, VIRGINIA

PREPARED FOR:
**VIRGINIA ELECTRIC AND POWER COMPANY
DOMINION**
5000 DOMINION BOULEVARD
GLEN ALLEN, VIRGINIA 23060


PREPARED BY:
GAI CONSULTANTS, INC.
4198 COX ROAD, SUITE 114
GLEN ALLEN, VA 23060

JANUARY 2016

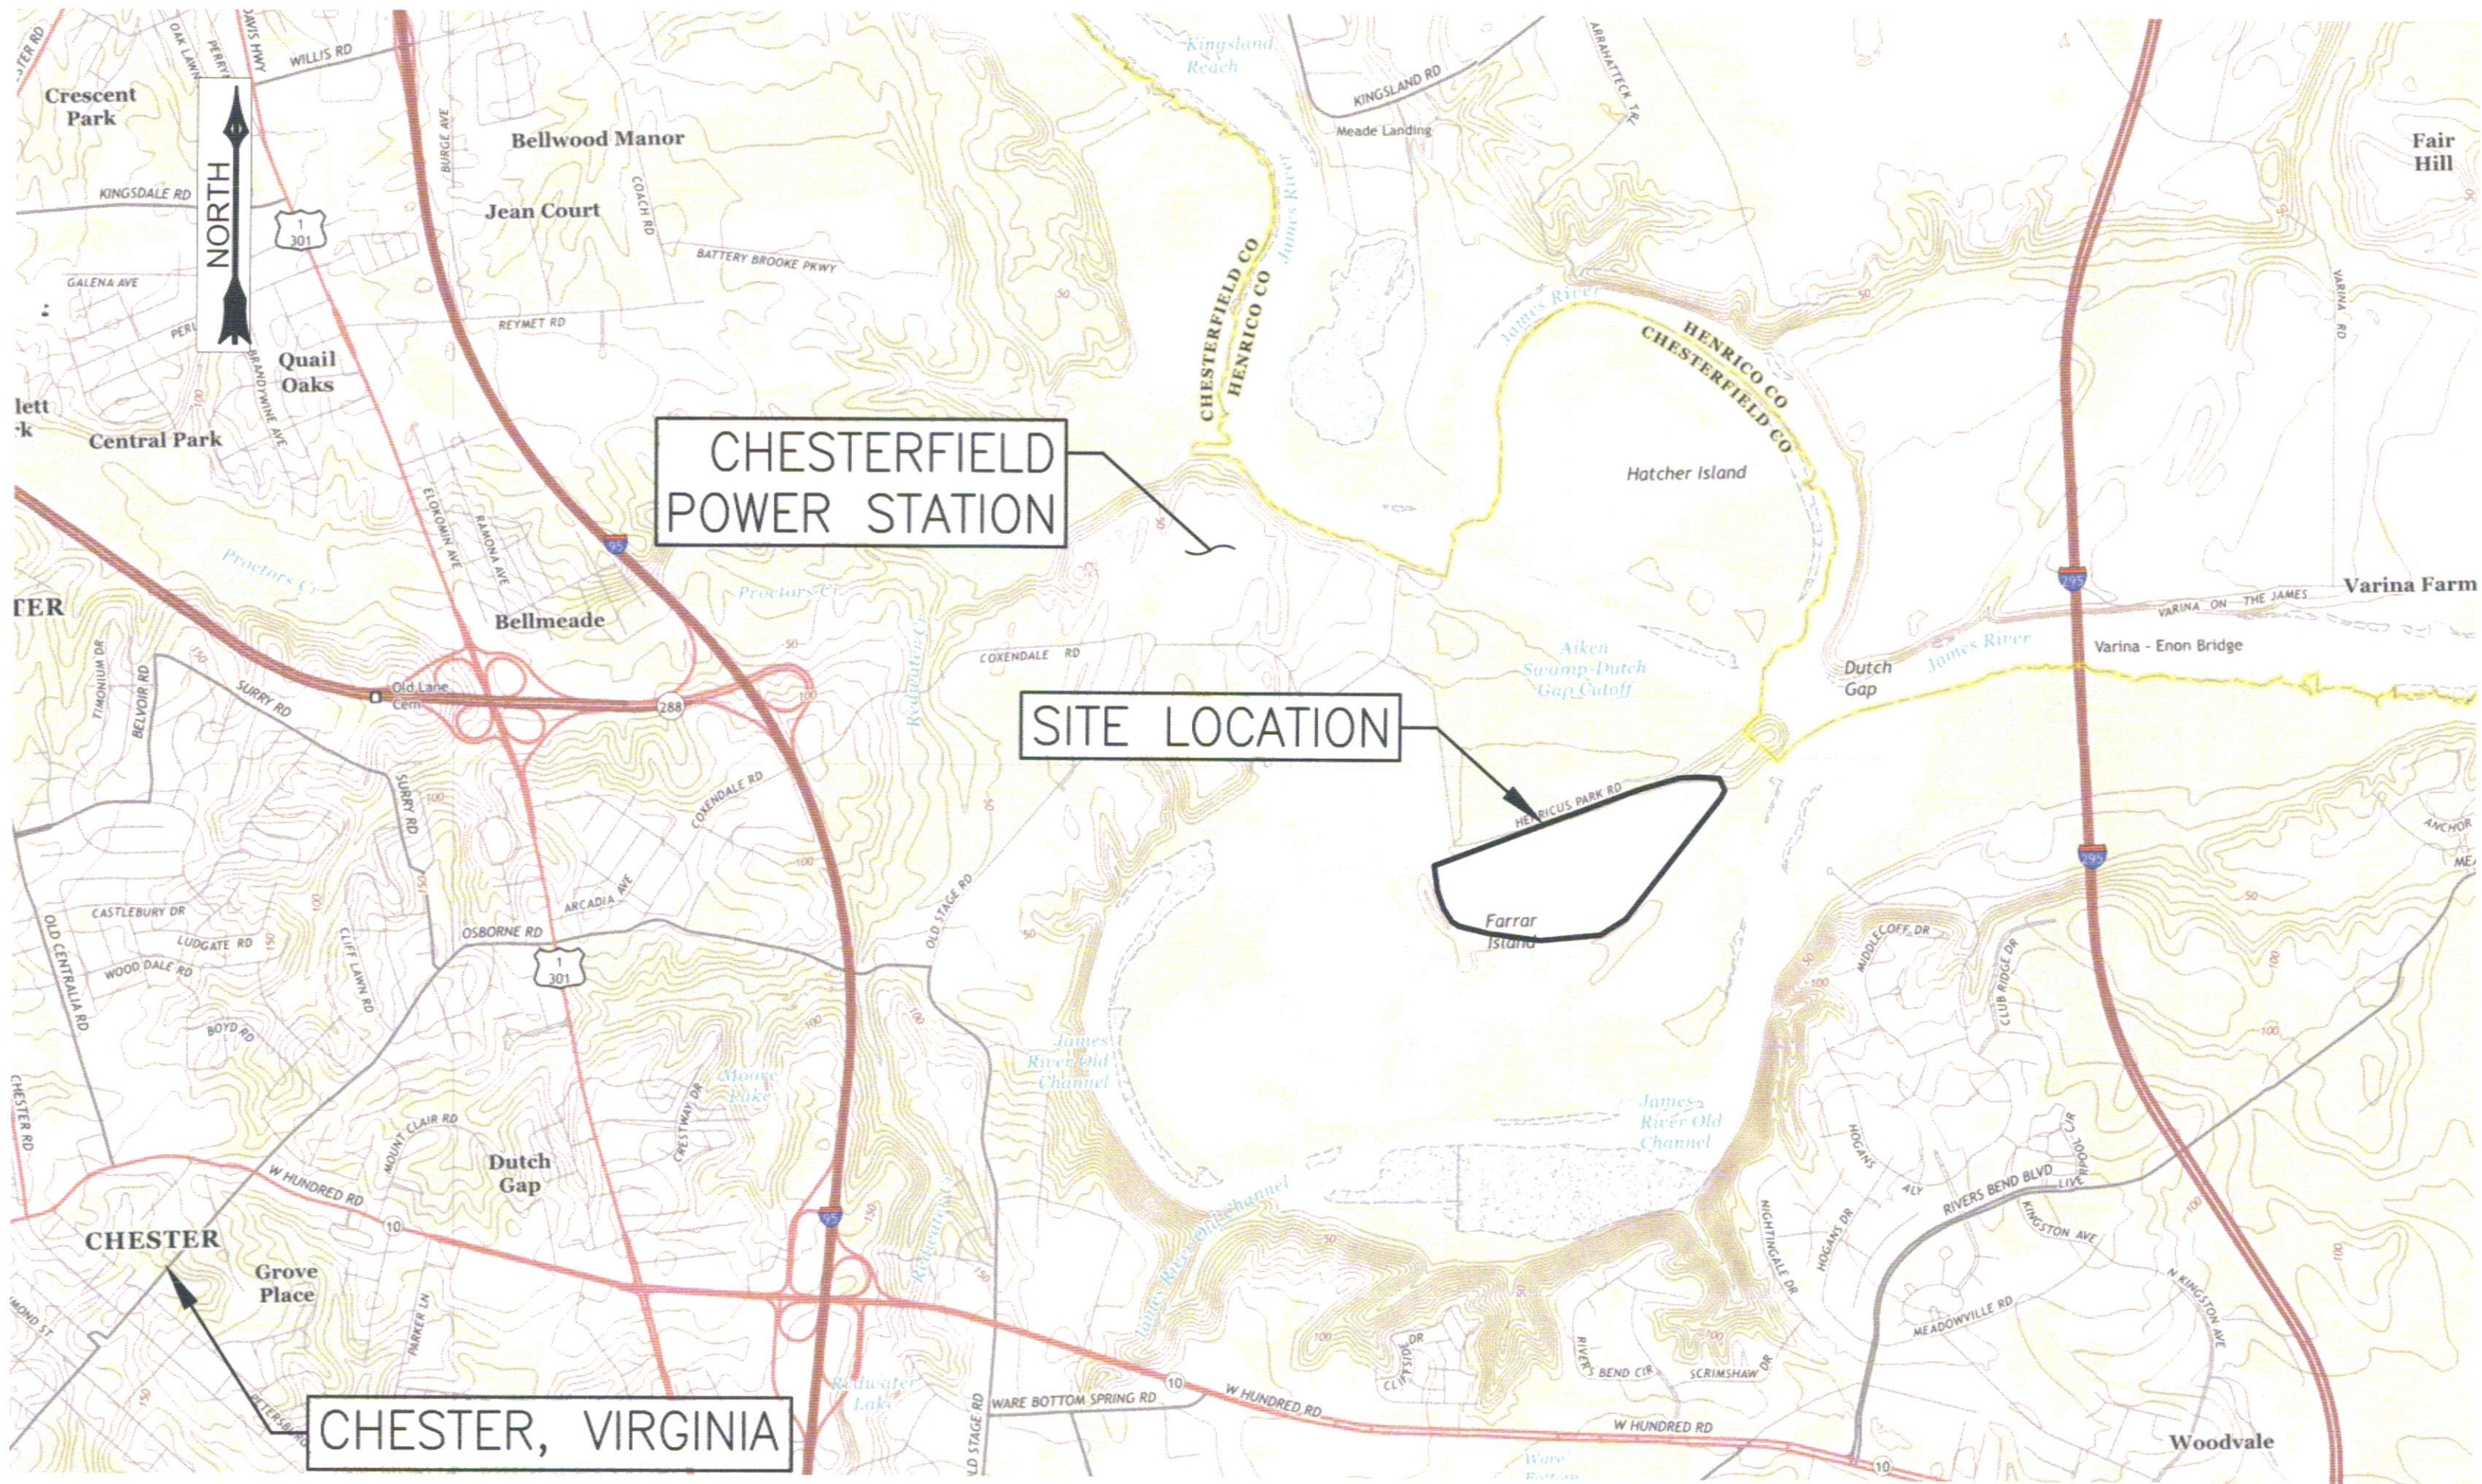


MAP REFERENCE:
USGS 7.5 MINUTE TOPOGRAPHIC QUADRANGLES:
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DUTCH GAP, VIRGINIA 1969, REVISED 1994
CHESTER, VIRGINIA 1994
HOPEWELL, VIRGINIA 1996.


SITE LOCATION MAP
1" = 2000'

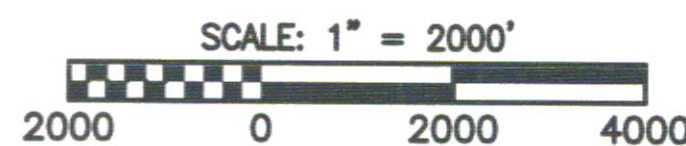


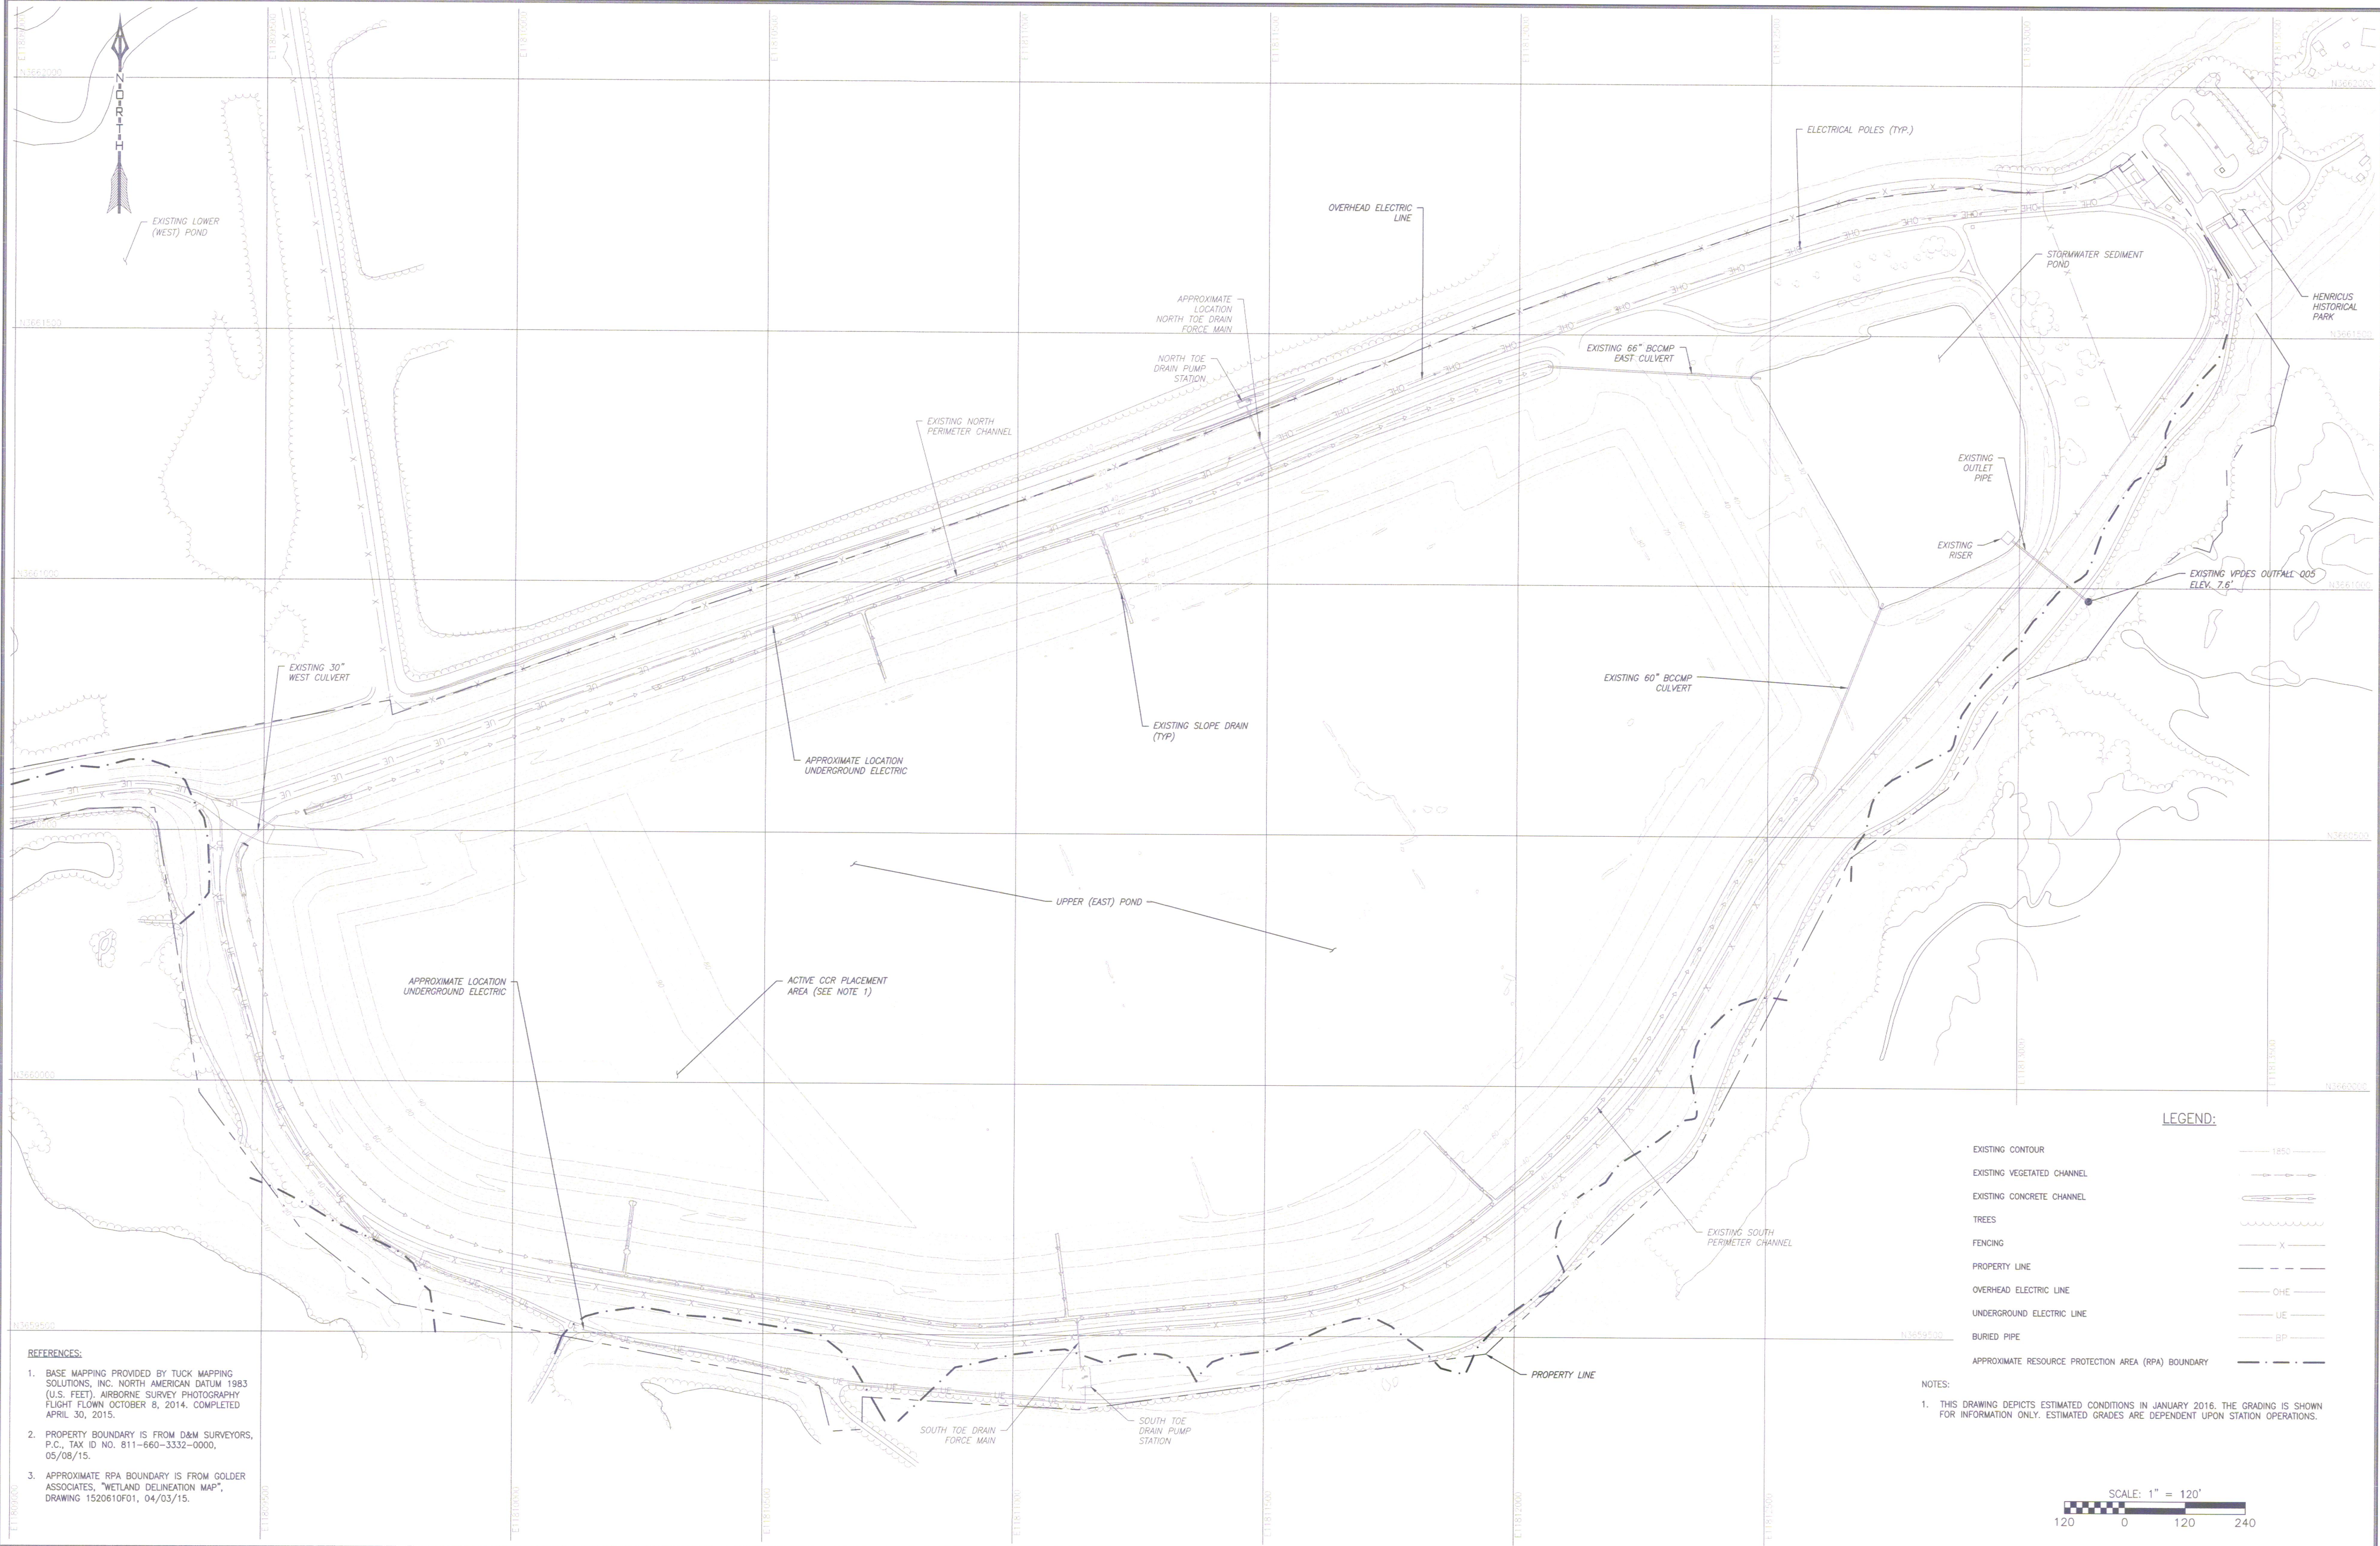
DRAWING INDEX		
GAI DRAWING FILE NUMBER	SHEET NUMBER	DRAWING TITLE
C150035-00-000-00-C-E1-101	1 OF 10	COVER SHEET
C150035-00-000-00-C-E1-102	2 OF 10	PLAN VIEW - EXISTING CONDITIONS
C150035-00-000-00-C-E1-103	3 OF 10	PLAN VIEW - SUBGRADE PLAN WITH CLOSURE CONSTRUCTION SEQUENCE
C150035-00-000-00-C-E1-104	4 OF 10	UPPER (EAST) POND FINAL CLOSURE ESTIMATED CONFIGURATION
C150035-00-000-00-C-E1-105	5 OF 10	ESTIMATED CONSTRUCTION SEQUENCE - AREA 5
C150035-00-000-00-C-E1-106	6 OF 10	CROSS SECTIONS
C150035-00-000-00-C-E1-107	7 OF 10	CROSS SECTIONS
C150035-00-000-00-C-E1-108	8 OF 10	CAP AND COVER DETAILS
C150035-00-000-00-C-E1-109	9 OF 10	CAP DRAIN, FORCE MAIN, AND PARKING DETAILS
C150035-00-000-00-C-E1-110	10 OF 10	DRAINAGE AND MISCELLANEOUS DETAILS

					DESCRIPTION:
A	1/7/2016	WJH	KMB	JDP	
NO.:	DATE:	DWN:	CHK:	APV:	
REVISION RECORD					
This drawing was produced with computer aided drafting technology and is supported by electronic drawing files. Do not revise this drawing via manual drafting methods.					
GAI CAD FILE PATH: Z:\Energy\2015\C150035-00 - DOM-Chesterfield Pond Closure\Permit\Production Drawings\C150035-00-000-00-C-E1-101.dwg PLOTTED ON: 1/7/2016 12:54:25 PM PLOTTED BY: Joe Neiman PLOT FILE: GAI.stb					

DRAWING TITLE		
COVER SHEET		
PROJECT		CLIENT
UPPER (EAST) POND CCR CLOSURE CHESTERFIELD POWER STATION CHESTERFIELD COUNTY, VIRGINIA	 gai consultants	DOMINION GLEN ALLEN, VIRGINIA
ISSUING OFFICE: Murrysville 4101 Triangle Lane, Export, PA 15632-1358		

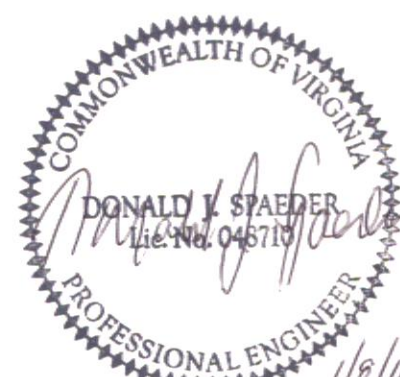


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DWG TYPE:	SCALE:	ISSUE DATE:	ALT./CLIENT DRAWING NUMBER:
	AS SHOWN	1/7/2016	
REVISION	SHEET NO.:	GAI DRAWING NUMBER:	
	1 OF 10	C150035-00-000-00-C-E1-101	



A	1/7/2016	JML	KMB	JDP	RELEASED FOR APPROVAL
NO.:	DATE:	DWN:	CHK:	APV:	DESCRIPTION:
REVISION RECORD					
This drawing was produced with computer aided drafting technology and is supported by electronic drawing files. Do not revise this drawing via manual drafting methods.					
GA CAD FILE PATH: Z:\Energy\2015\150035.00 - BDM-Chesterfield Pond Closure\CAD\Permit\Production Drawings\150035-00-000-C-E1-102.dwg PLOTTED ON: 1/7/2016 12:45:55 PM PLOTTED BY: Joe Neiman PLOT FILE: GAI.stb					

DRAWING TITLE	
PLAN VIEW - EXISTING CONDITIONS	
PROJECT	CLIENT
UPPER (EAST) POND CCR CLOSURE	DOMINION
CHESTERFIELD POWER STATION	GLEN ALLEN, VIRGINIA
CHESTERFIELD COUNTY, VIRGINIA	
ISSUING OFFICE: Murrysville 4200 Triangle Lane, Export, PA 15632-1358	




gai consultants

CLIENT


DOMINION



GLEN ALLEN, VIRGINIA




1/6/16

DRAWN BY:	CHECKED BY:	APPROVED BY:	GAI FILE NUMBER:
LEIDYJM	BORTZKM	PHILLJD	C150035-00-000-00-C-E1-102
DWG TYPE:	SCALE:	ISSUE DATE:	ALT./CLIENT DRAWING NUMBER:
AS SHOWN	1/7/2016		
REVISION	SHEET NO.:	GAI DRAWING NUMBER:	
A	2 OF 10	E1-102	

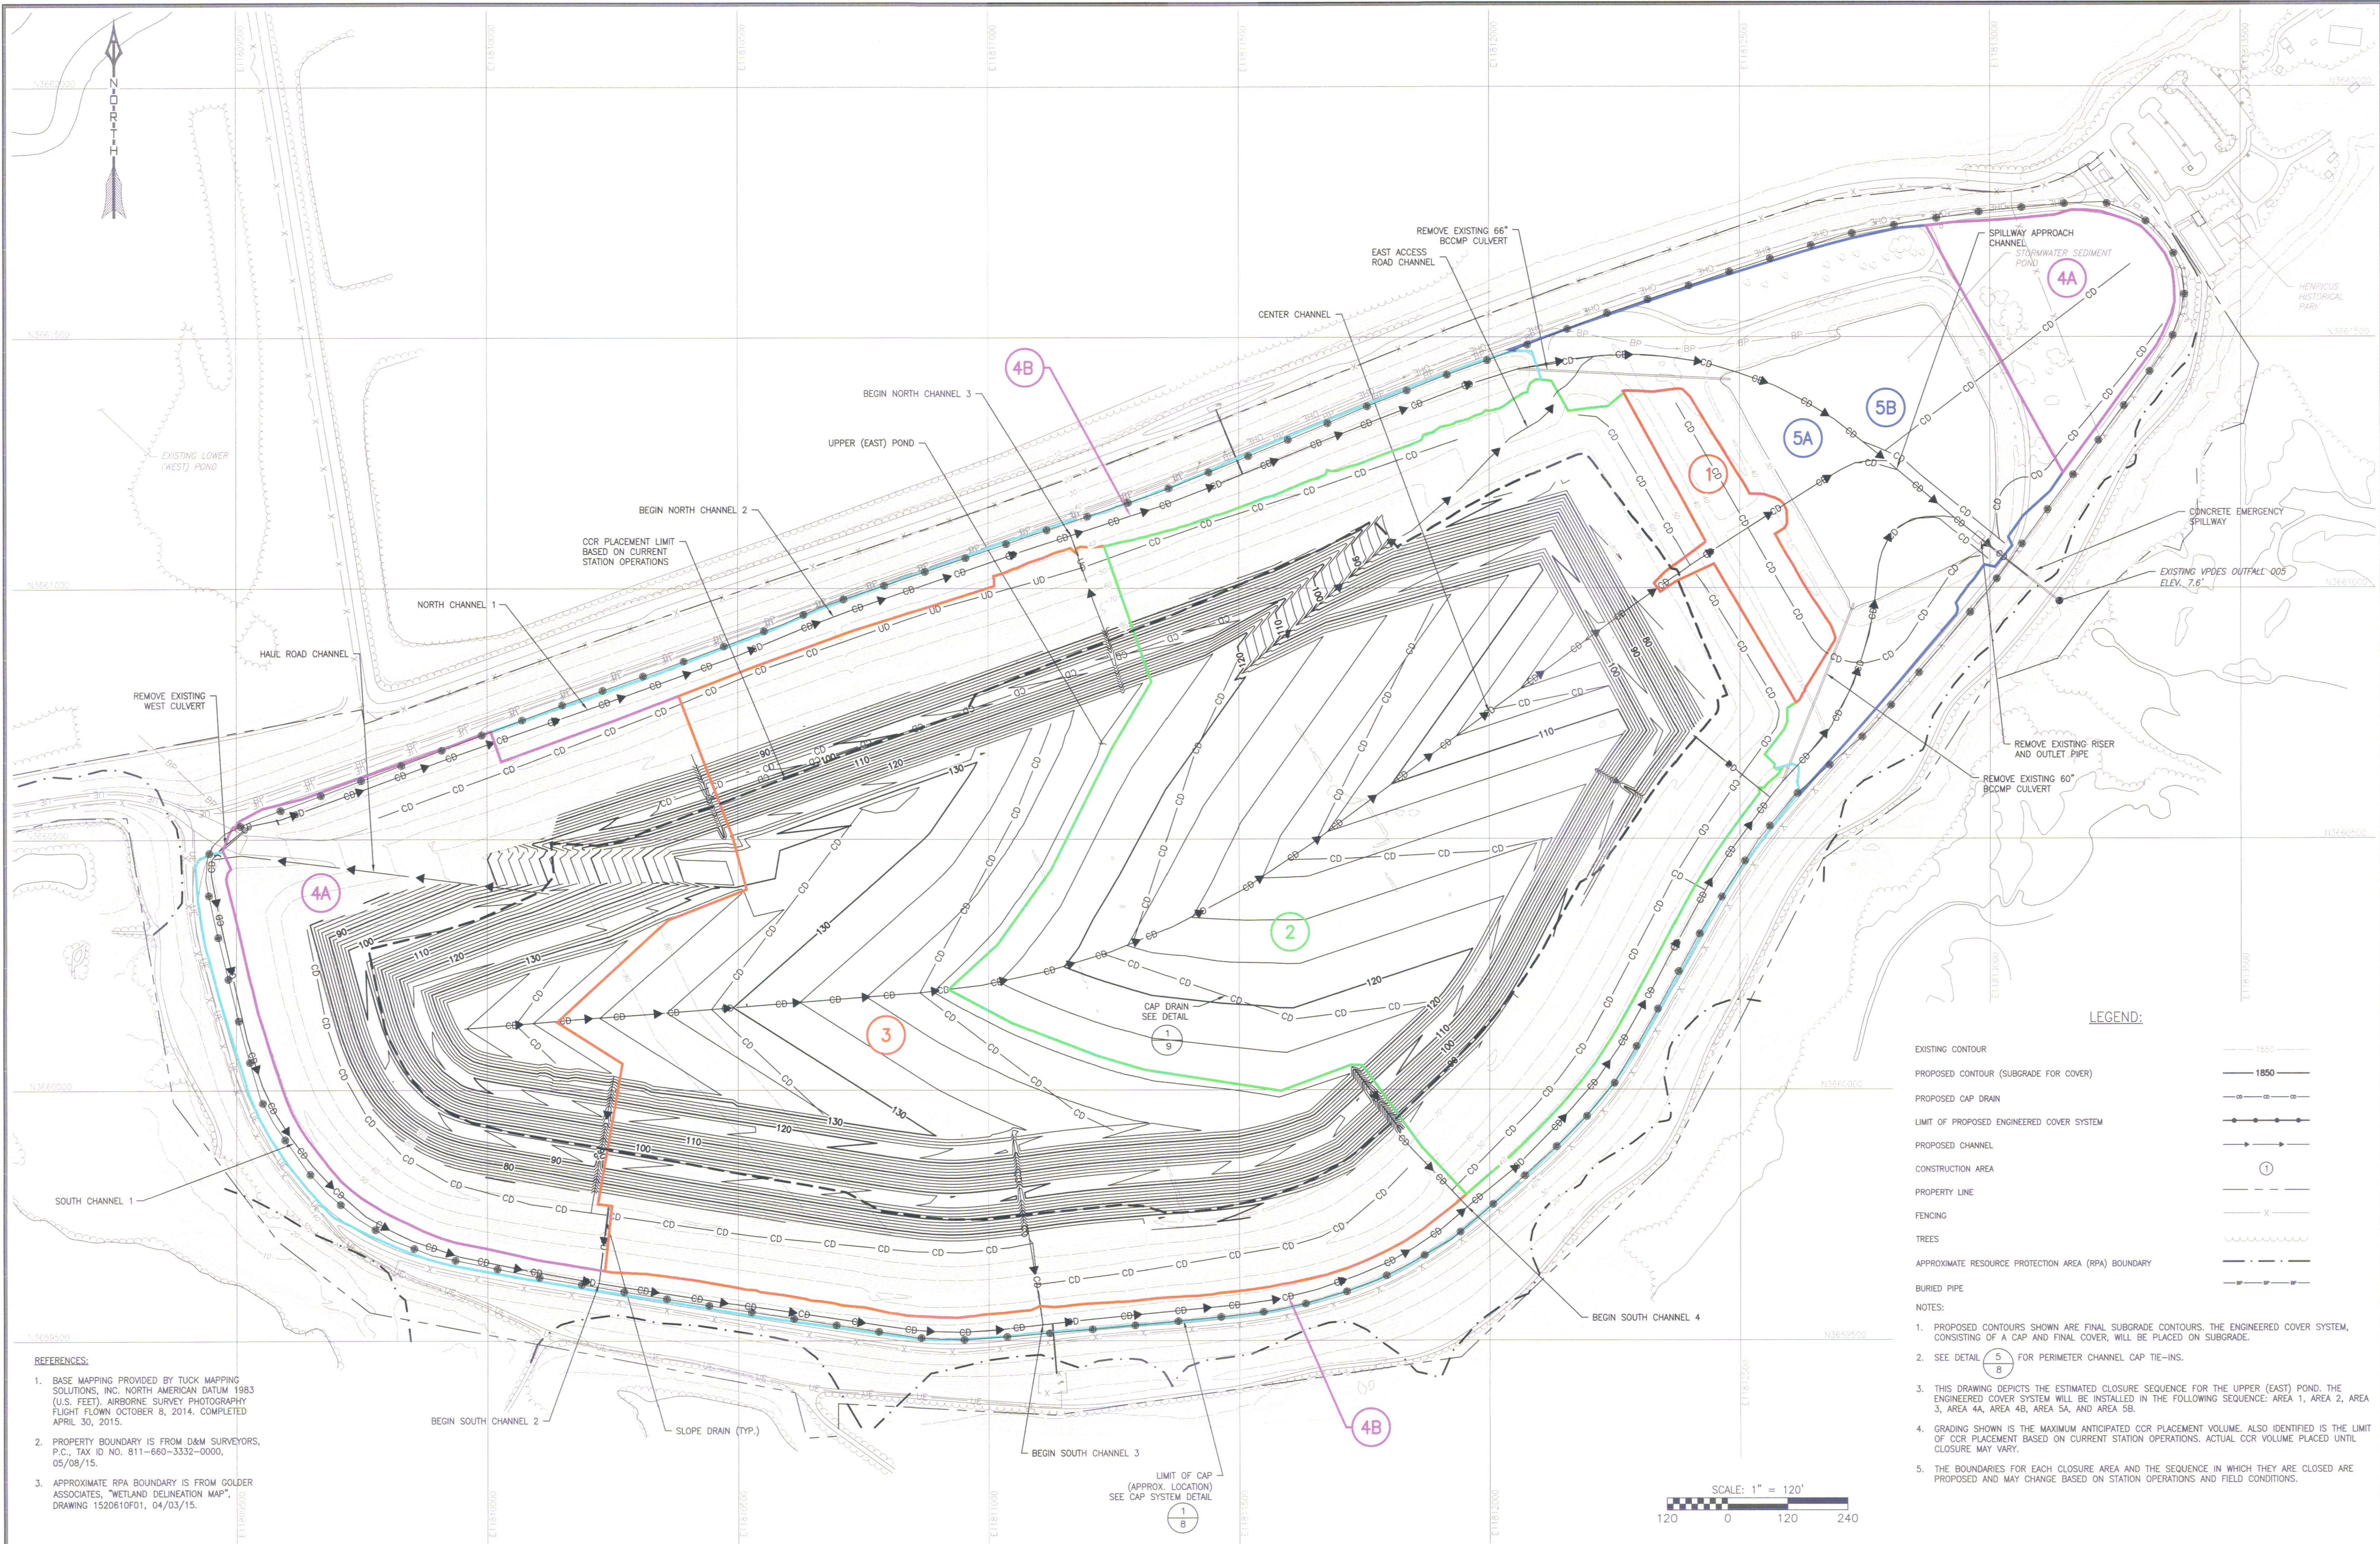

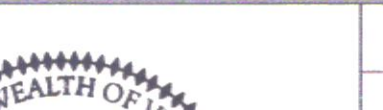						DRAWING TITLE			DRAWN BY:	CHECKED BY:	APPROVED BY:	GAI FILE NUMBER:
						PLAN VIEW - SUBGRADE PLAN WITH CLOSURE CONSTRUCTION SEQUENCE			LEIDYJM	BORTZKM	PHILLJD	C150035-00-000-00-C-E1-103
						PROJECT			CLIENT			
						UPPER (EAST) POND CCR CLOSURE			 gai consultants		DOMINION	
						CHESTERFIELD POWER STATION					GLEN ALLEN, VIRGINIA	
						CHESTERFIELD COUNTY, VIRGINIA						
						ISSUING OFFICE: Murrys ville 4200 Triangle Lane, Export, PA 15632-1358						

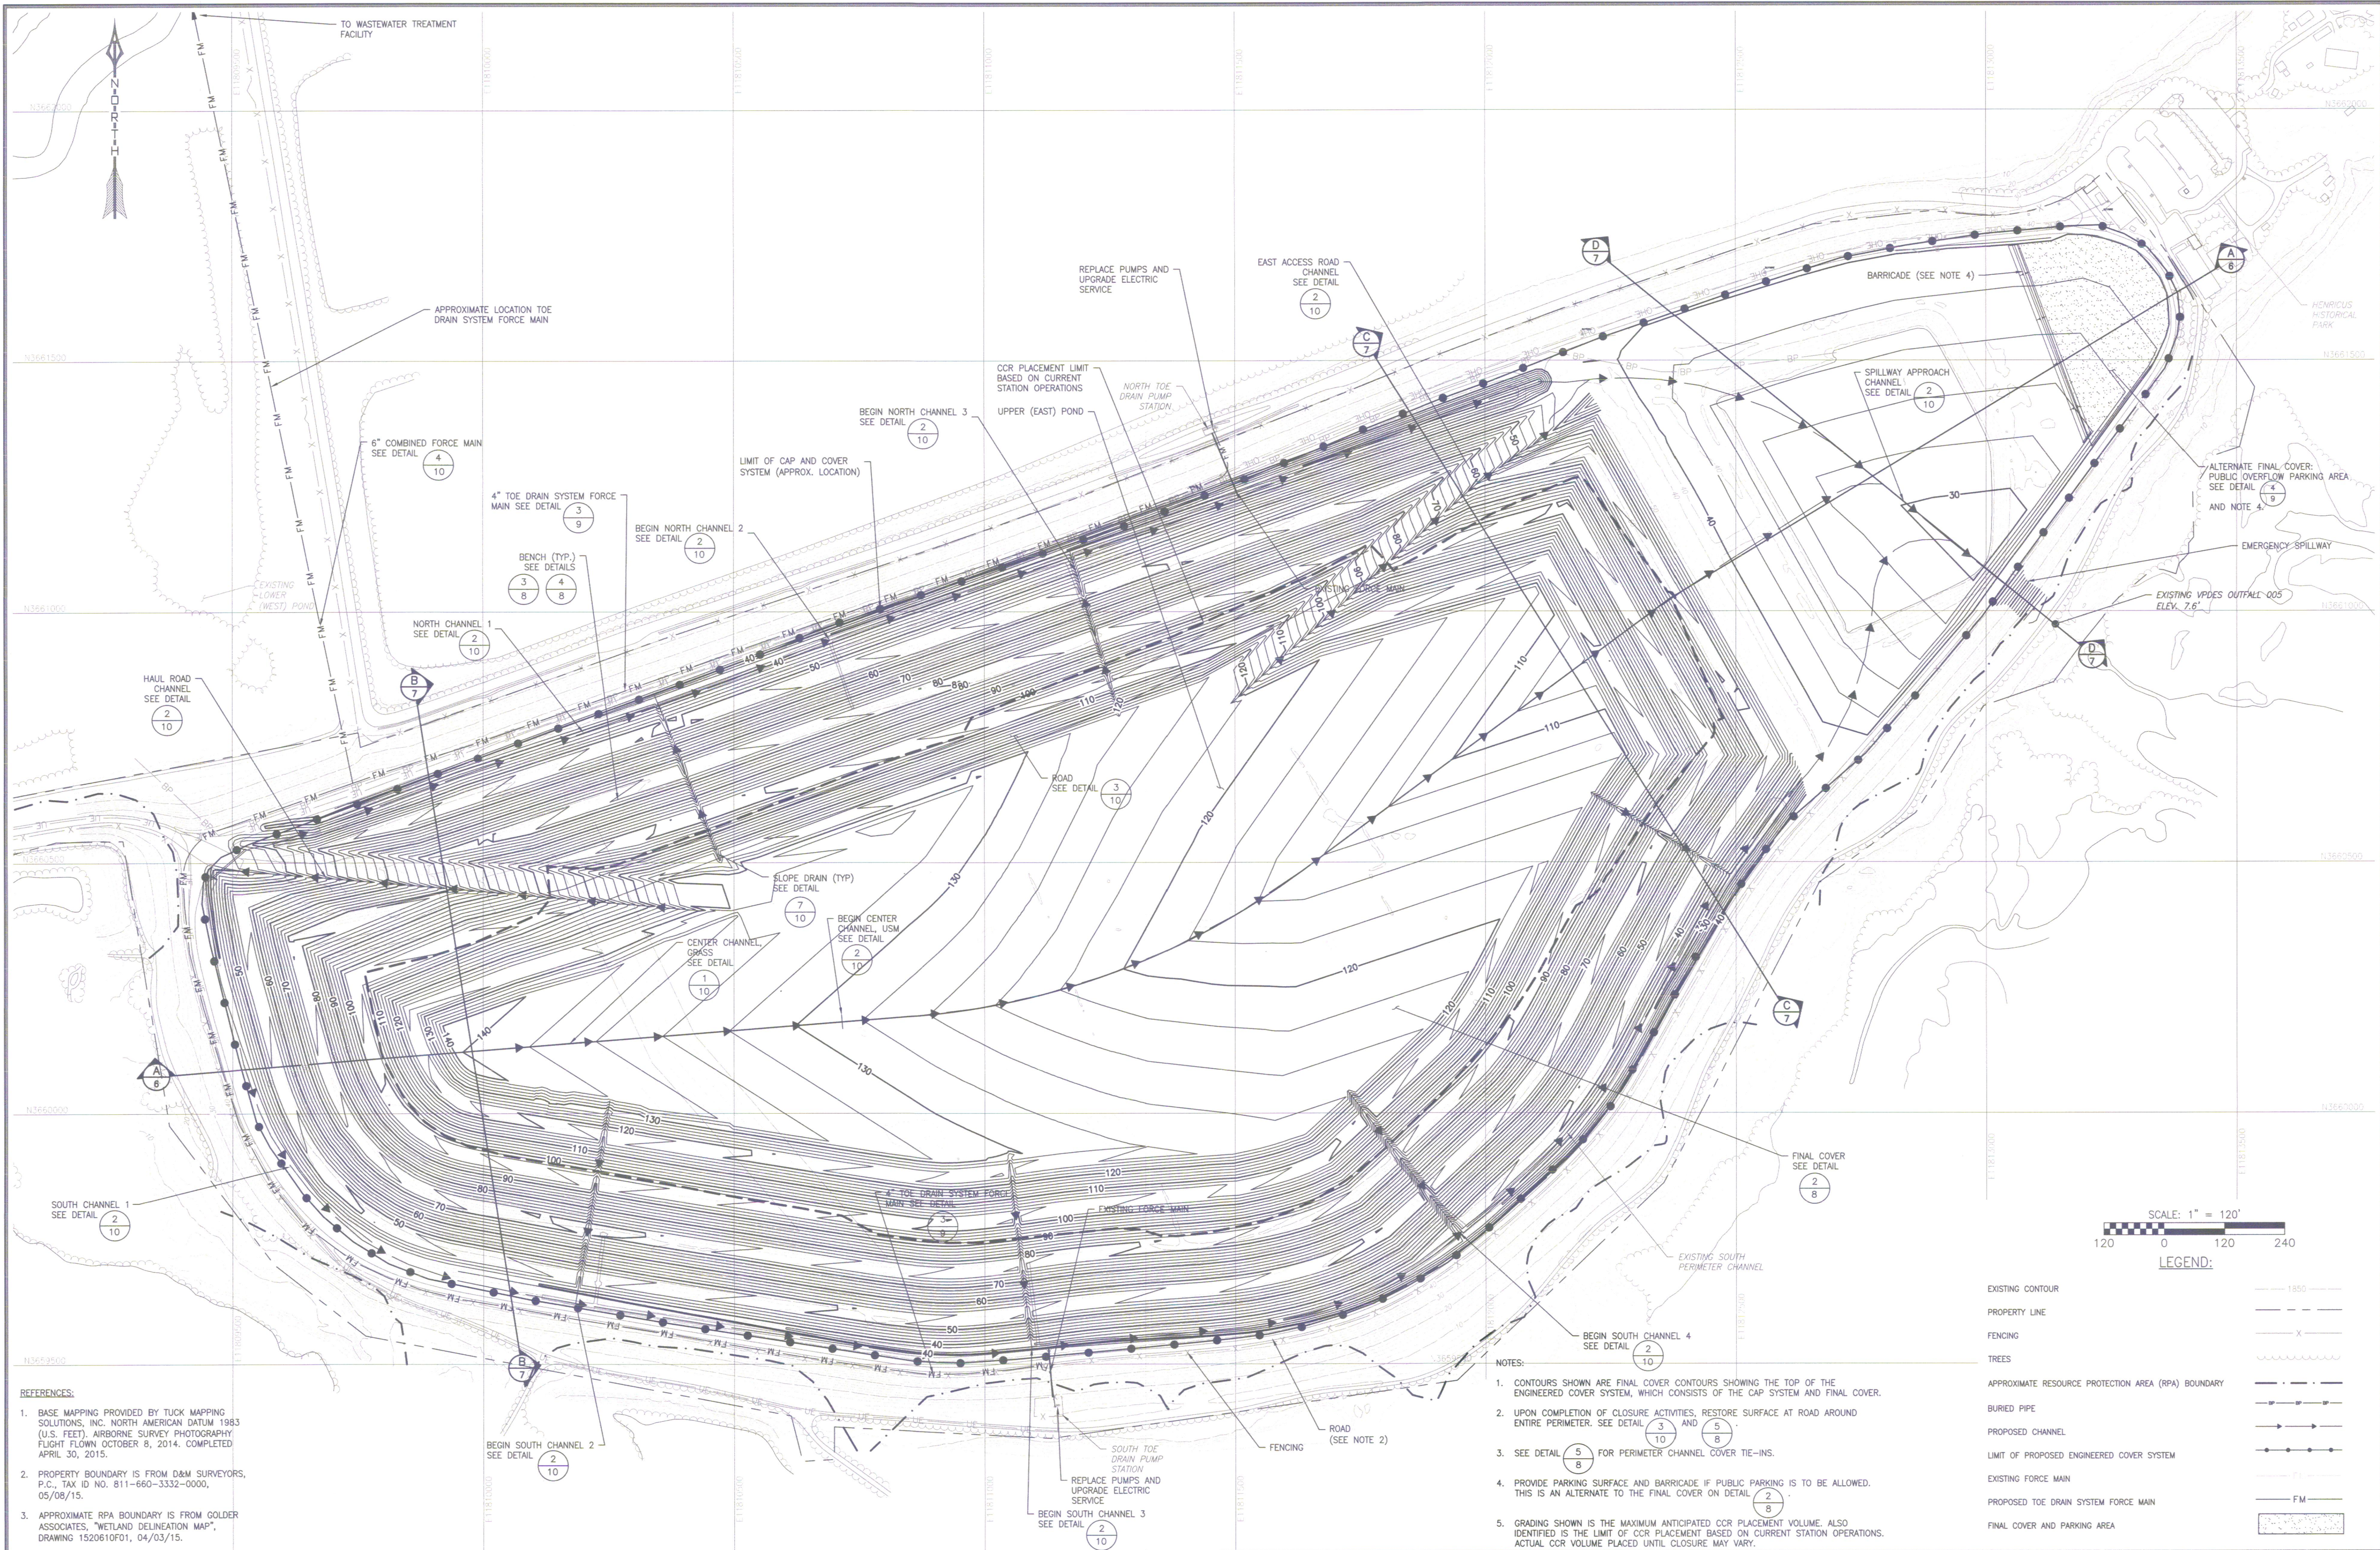

REFERENCES:

1. BASE MAPPING PROVIDED BY TUCK MAPPING SOLUTIONS, INC. NORTH AMERICAN DATUM 1983 (U.S. FEET), AIRBORNE SURVEY PHOTOGRAPHY FLIGHT FLOWN OCTOBER 8, 2014. COMPLETED APRIL 30, 2015.

2. PROPERTY BOUNDARY IS FROM D&M SURVEYORS, P.C., TAX ID NO. 811-660-3332-0000, 05/08/15.

3. APPROXIMATE RPA BOUNDARY IS FROM GOLDER ASSOCIATES, "WETLAND DELINEATION MAP", DRAWING 1520610F01, 04/03/15.

REVISION RECORD

NO.	DATE	DWN	CHK	APV	DESCRIPTION
A	1/7/2016	JML	KMB	JDP	RELEASED FOR APPROVAL

DESCRIPTION:

UPPER (EAST) POND CCR CLOSURE
CHESTERFIELD POWER STATION
CHESTERFIELD COUNTY, VIRGINIA

ISSUING OFFICE:

Murrysville | 4200 Triangle Lane, Export, PA 15632-1358

PROJECT

UPPER (EAST) POND CCR CLOSURE
CHESTERFIELD POWER STATION
CHESTERFIELD COUNTY, VIRGINIA

CLIENT

DOMINION
GLEN ALLEN, VIRGINIA

PROFESSIONAL ENGINEER

Donna L. Spitzer
Lic. No. 64810
1/9/16

DRAWN BY:

LEIDYJM

CHECKED BY:

BORTZKM

APPROVED BY:

PHILLJD

GAI FILE NUMBER:

C150035-00-000-00-C-E1-104

DWG TYPE:

AS SHOWN

SCALE:

1/7/2016

ISSUE DATE:

1/7/2016


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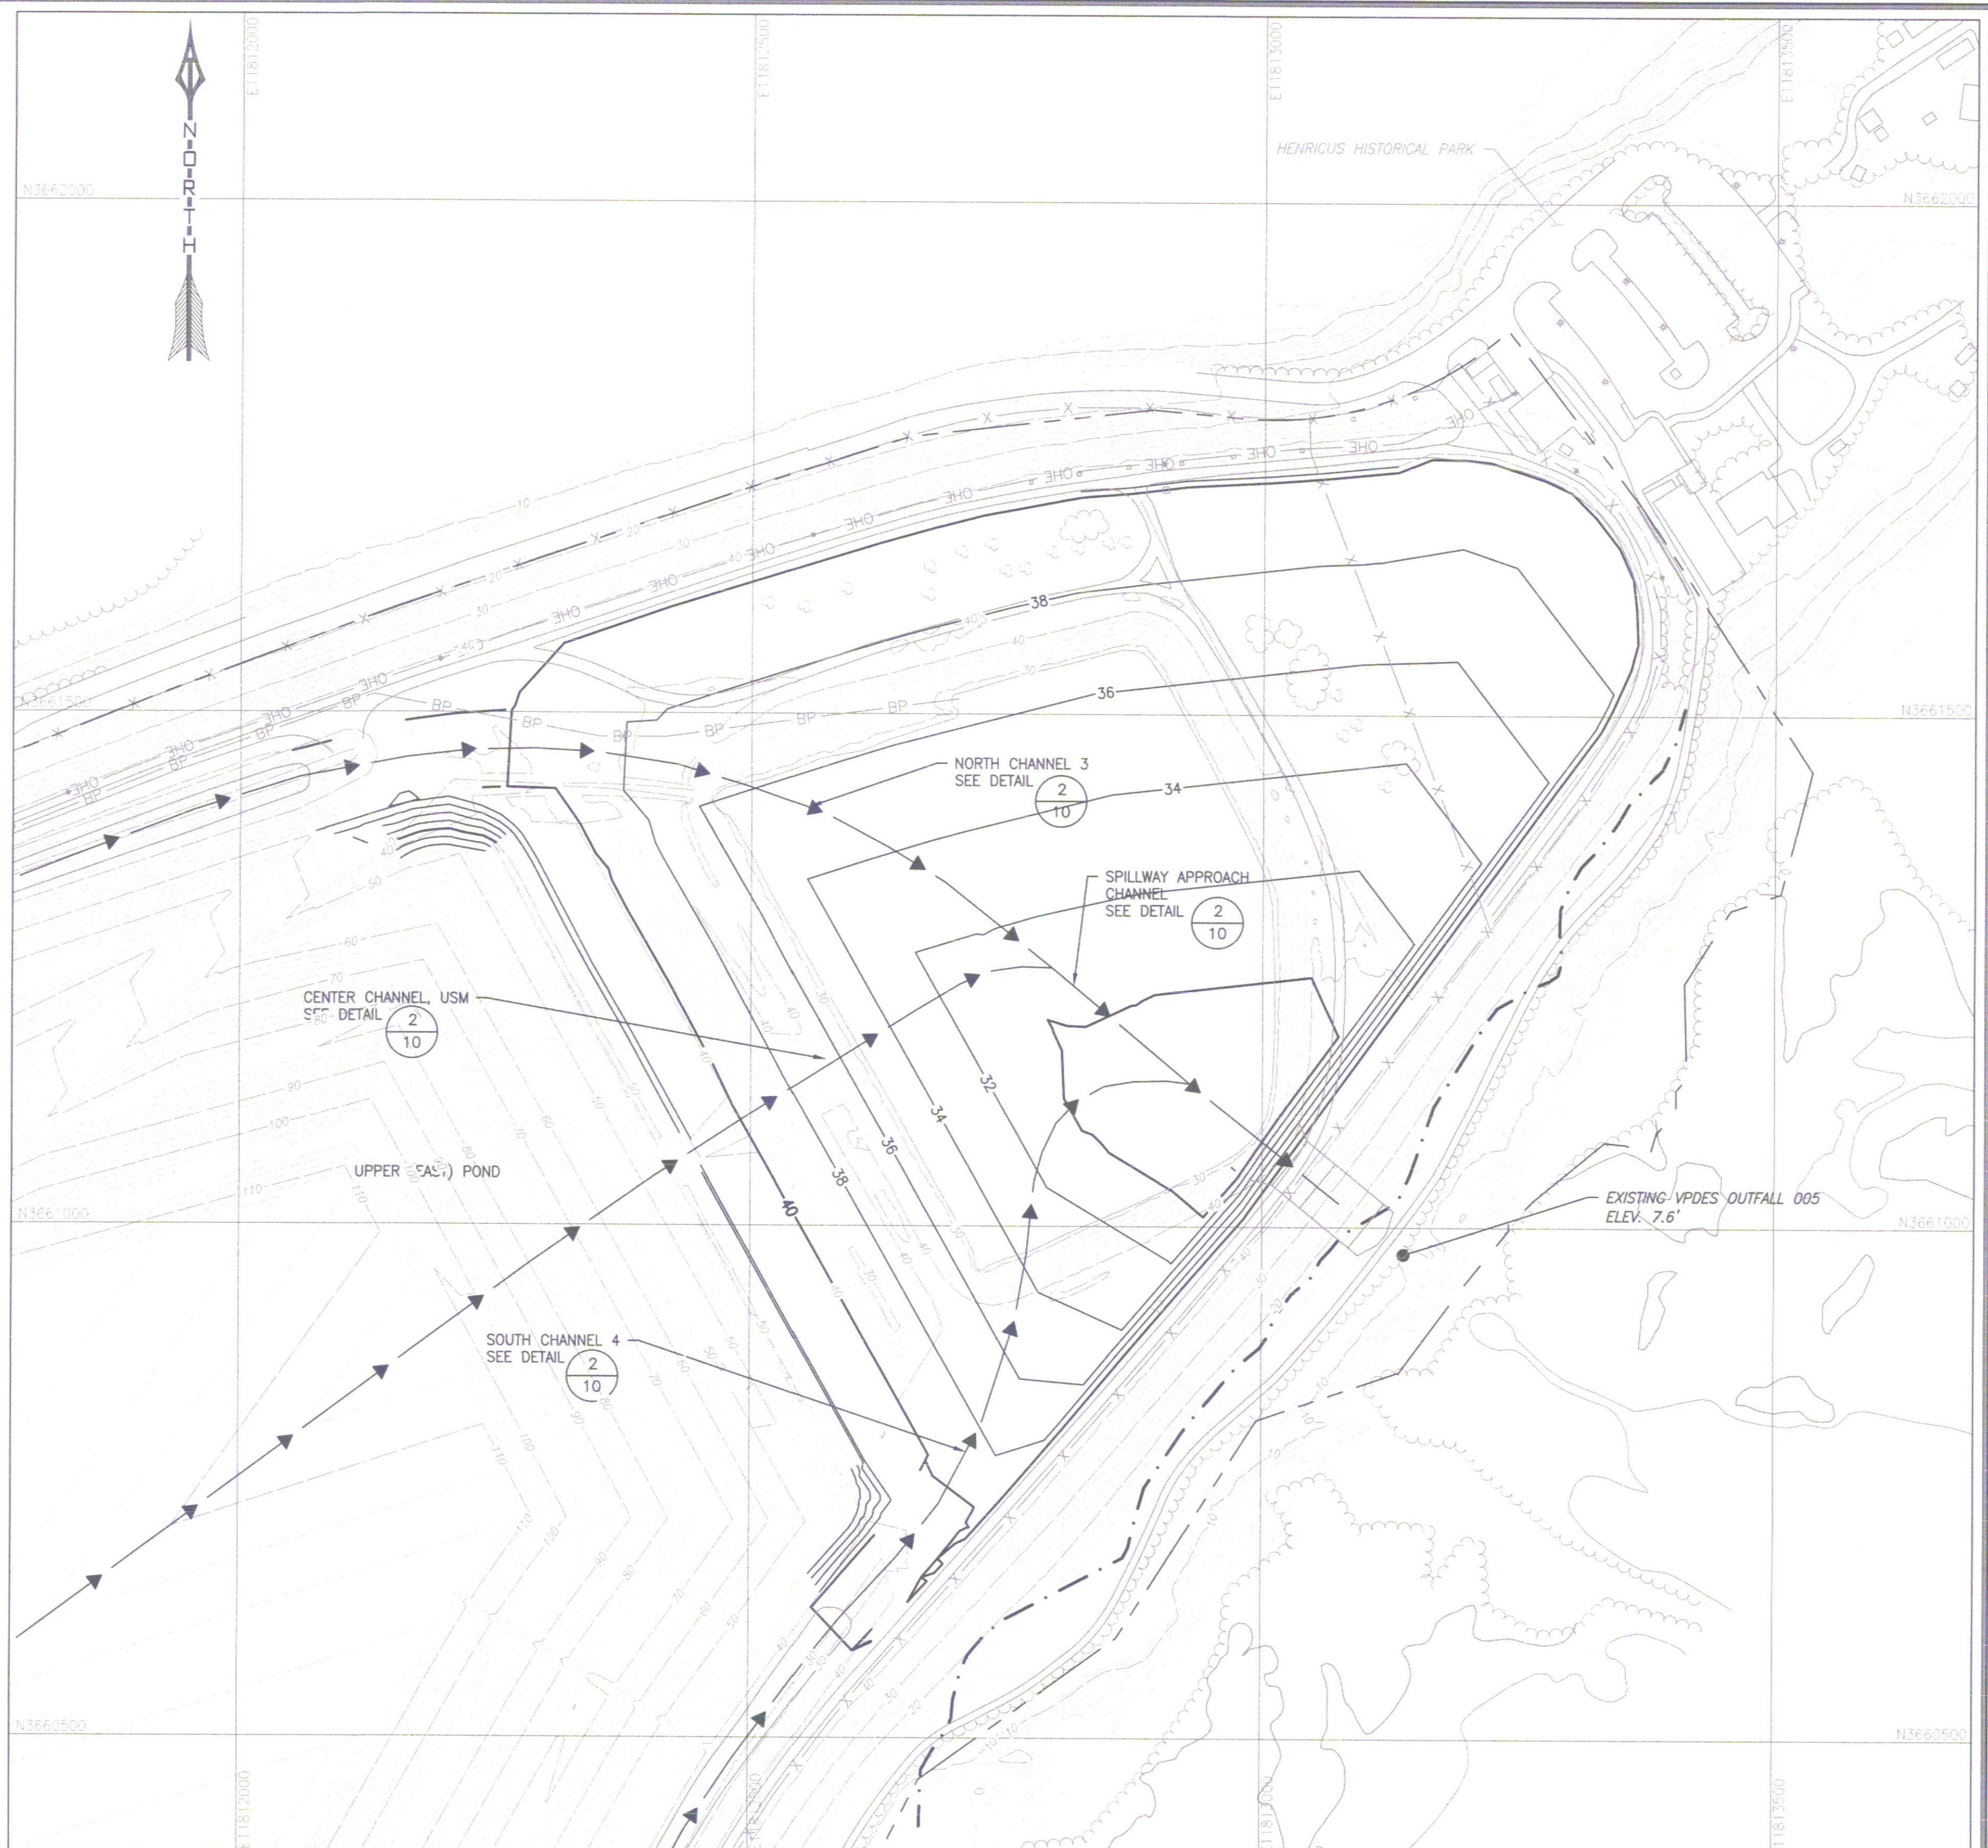
4 OF 10

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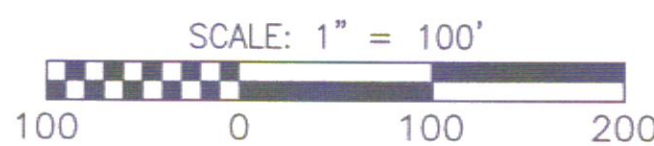
C150035-00-000-00-C-E1-104



STORMWATER SEDIMENT POND DIVERSION
SCALE: 1" = 100'

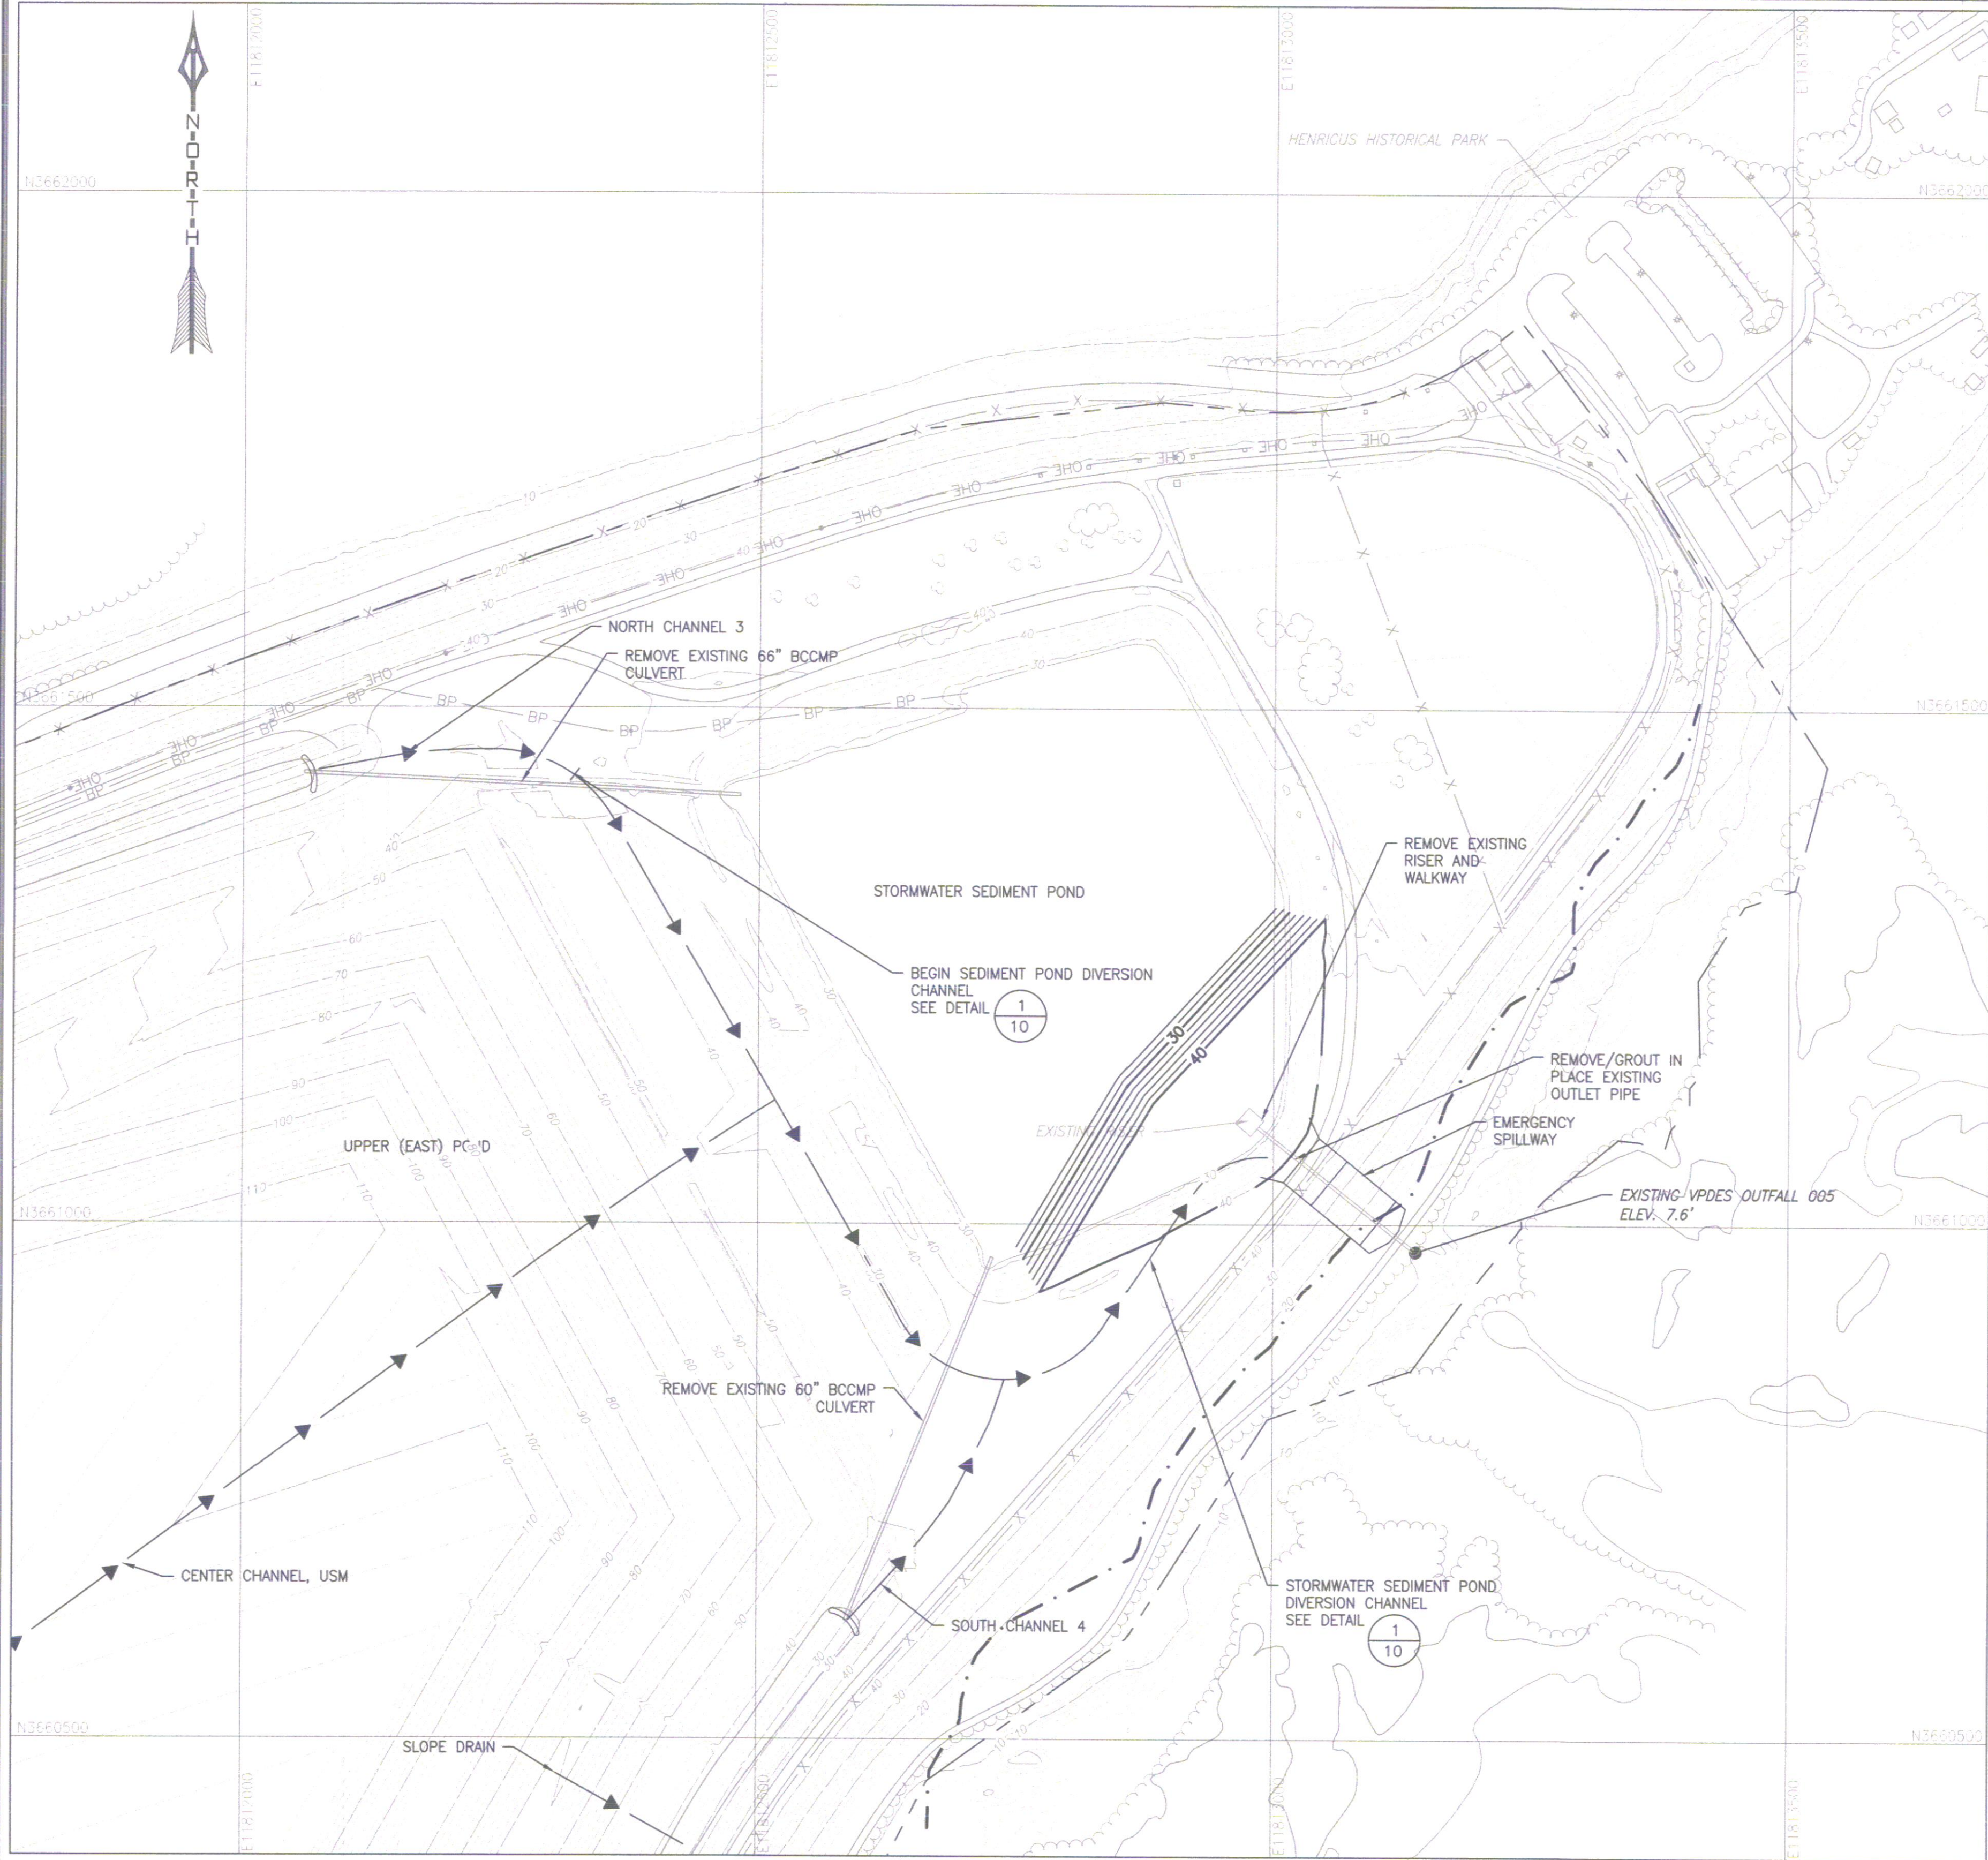

AREA 5 FINAL COVER
SCALE: 1" = 100'



LEGEND:


EXISTING CONTOUR	— 50 —
PROPOSED CONTOUR	— 50 —
PROPERTY LINE	— —
EXISTING FENCING	— X —
EXISTING TREES	~~~~~
APPROXIMATE RESOURCE PROTECTION AREA (RPA) BOUNDARY	- - - -
BURIED PIPE	— BP —

- NOTES:
- THIS DRAWING DEPICTS CONDITIONS DURING THE CLOSURE OF AREA 5.

REFERENCES:



- BASE MAPPING PROVIDED BY TUCK MAPPING SOLUTIONS, INC. NORTH AMERICAN DATUM 1983 (U.S. FEET). AIRBORNE SURVEY PHOTOGRAPHY FLIGHT FLOWN OCTOBER 8, 2014. COMPLETED APRIL 30, 2015.
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A	1/7/2016	JDS	KMB	JDP	RELEASED FOR APPROVAL
NO.:	DATE:	DWN:	CHK:	APV:	DESCRIPTION:
REVISION RECORD					
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GA: CAD FILE PATH: Z:\Energy\2019\C150035-00 - DOM-Chesterfield Pond Closure\CAD\Permit\Production Drawings\C150035-00-000-00-C-E1-105.dwg PLOTTED ON: 1/7/2016 1:00:38 PM PLOTTED BY: Joe Neuman PLOT FILE: GA105					

DRAWING TITLE		
ESTIMATED CONSTRUCTION SEQUENCE - AREA 5		
PROJECT		CLIENT
UPPER (EAST) POND CCR CLOSURE		DOMINION
CHESTERFIELD POWER STATION		GLEN ALLEN, VIRGINIA
CHESTERFIELD COUNTY, VIRGINIA		
ISSUING OFFICE: Murrysville 4101 Triangle Lane, Export, PA 15632-1358		



DRAWN BY:	CHECKED BY:	APPROVED BY:	GA: FILE NUMBER:
SLODOJD	BORTZKM	PHILLJD	C150035-00-000-00-C-E1-105
DWG TYPE:	SCALE:	ISSUE DATE:	ALT./CLIENT DRAWING NUMBER:
AS SHOWN		1/7/2016	
REVISION	SHEET NO.:		GA: DRAWING NUMBER:
A	5 OF 10		C150035-00-000-00-C-E1-105

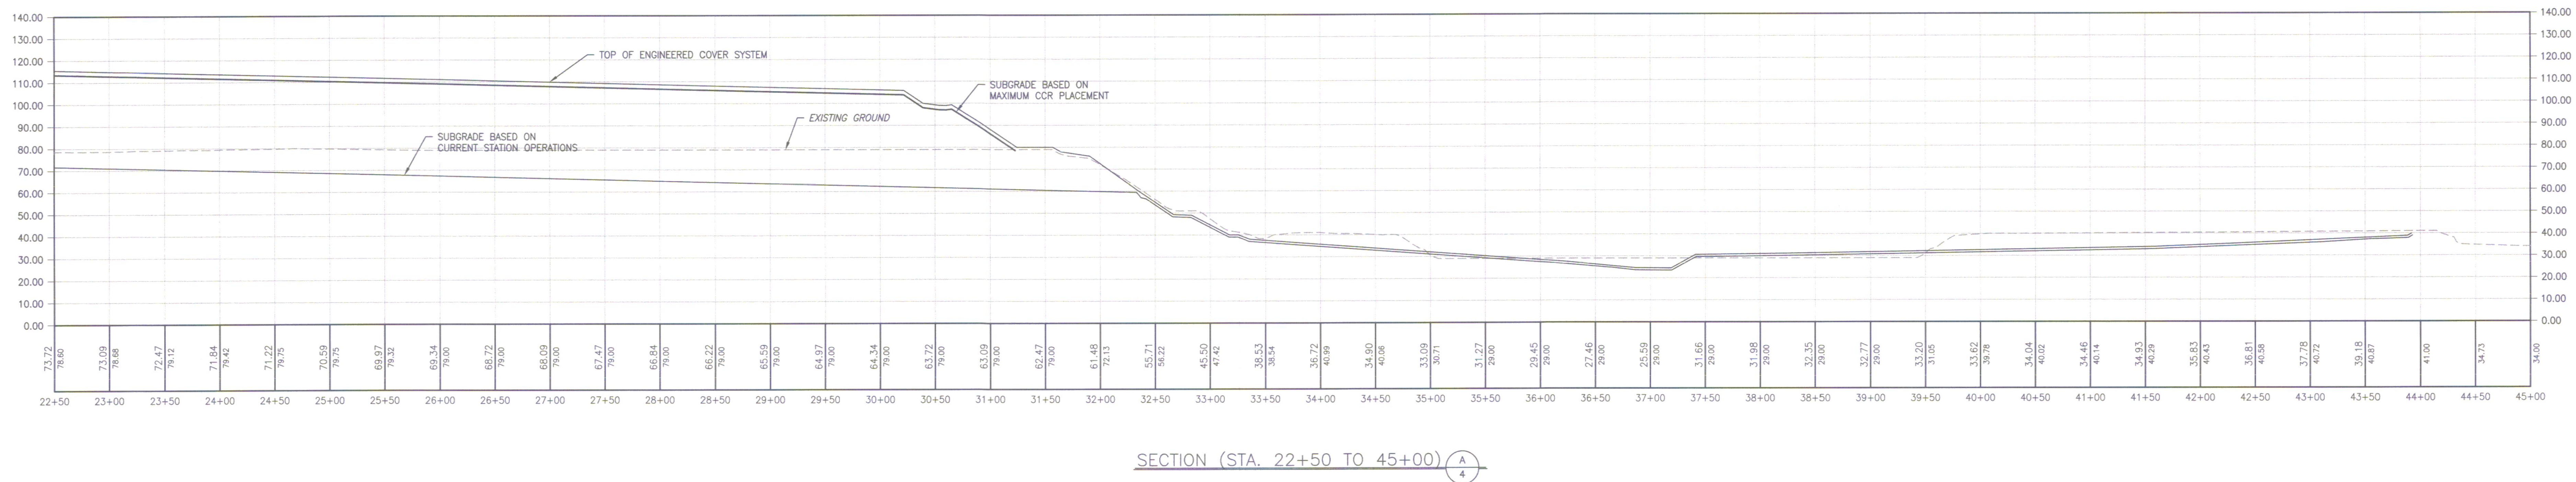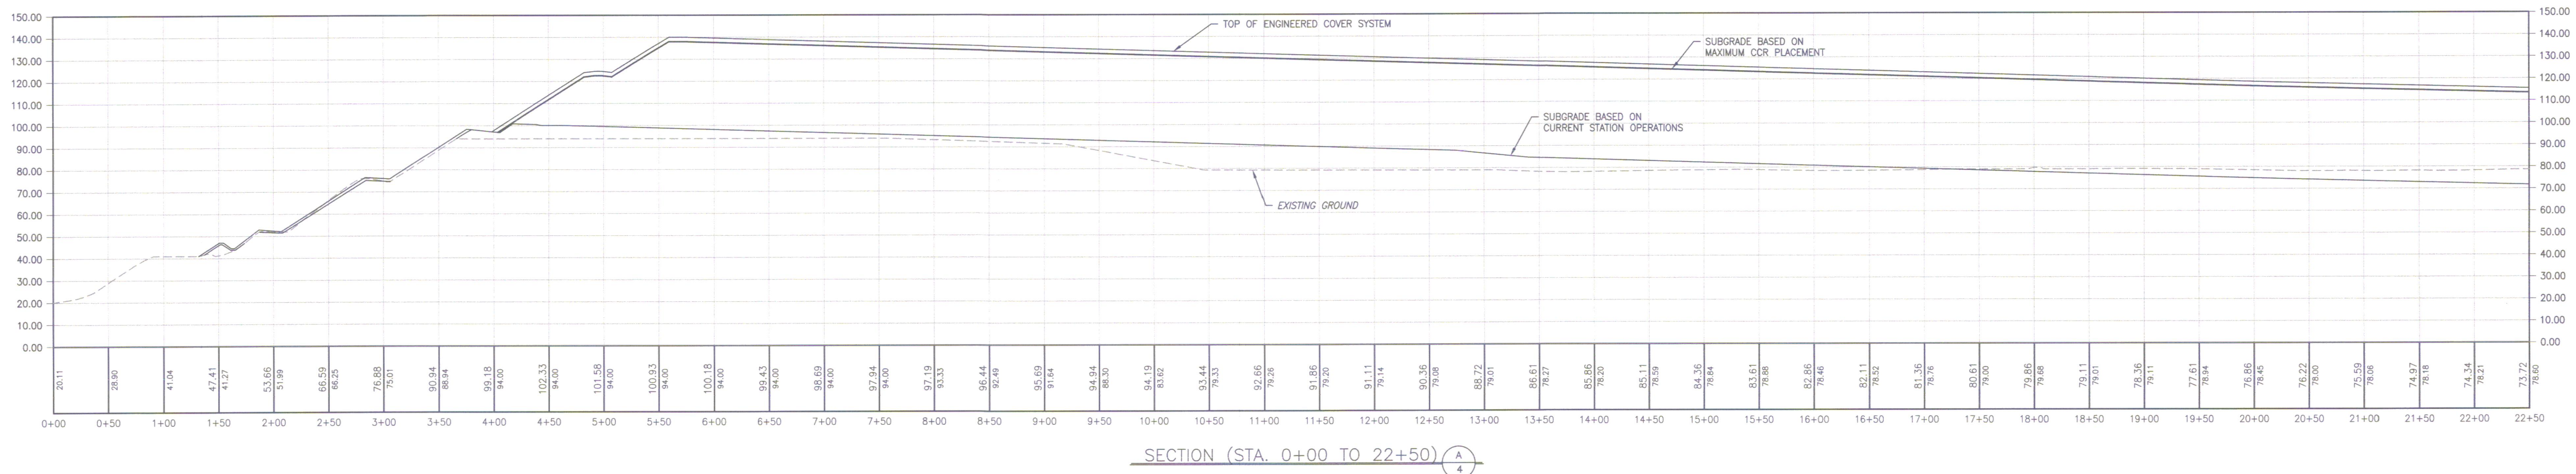

NOTE:
1. ELEVATIONS AND GRADES ARE BASED ON ESTIMATED CLOSURE CONDITIONS. FINAL ELEVATIONS MAY VARY BASED ON ACTUAL VOLUME OF CCR PLACED TO CLOSURE.






A	1/7/2016	JDS	KMB	JDP	RELEASED FOR APPROVAL
NO.	DATE:	DWN:	CHK:	APV:	DESCRIPTION:
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DRAWING TITLE		
CROSS SECTIONS		
PROJECT		CLIENT
UPPER (EAST) POND CCR CLOSURE CHESTERFIELD POWER STATION CHESTERFIELD COUNTY, VIRGINIA		DOMINION GLEN ALLEN, VIRGINIA
ISSUING OFFICE: Pittsburgh 385 E. Waterfront Drive, Homestead, PA 15120		



DRAWN BY:	CHECKED BY:	APPROVED BY:	GAI FILE NUMBER:
SLODOJD	BORTZKM	PHILLJD	C150035-00-000-00-C-E1-106
DWG TYPE:	SCALE:	ISSUE DATE:	ALT./CLIENT DRAWING NUMBER:
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REVISION	SHEET NO.:		GAI DRAWING NUMBER:
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
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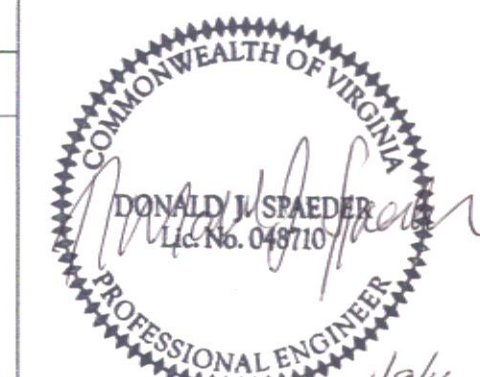
1. ELEVATIONS AND GRADES ARE BASED ON ESTIMATED CLOSURE CONDITIONS. FINAL ELEVATIONS MAY VARY BASED ON ACTUAL VOLUME OF CCR PLACED TO CLOSURE.

HORIZONTAL SCALE: 1" = 60'

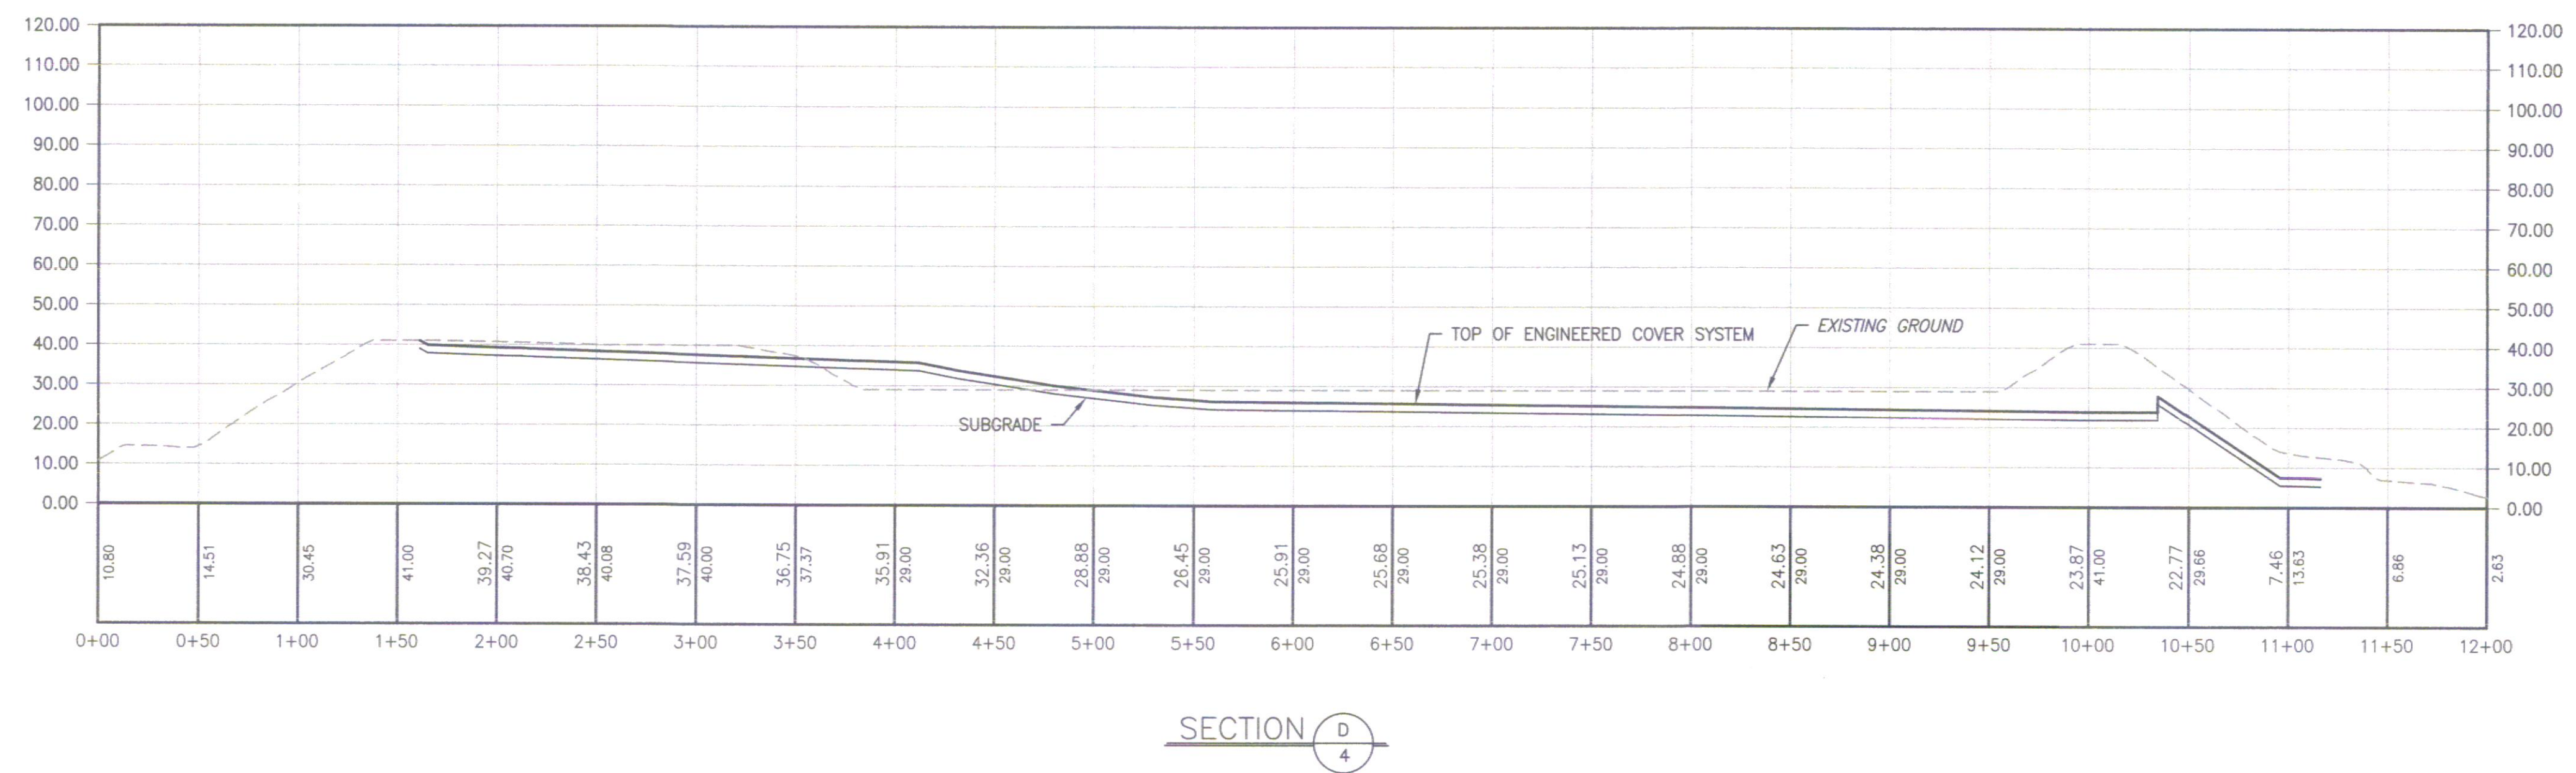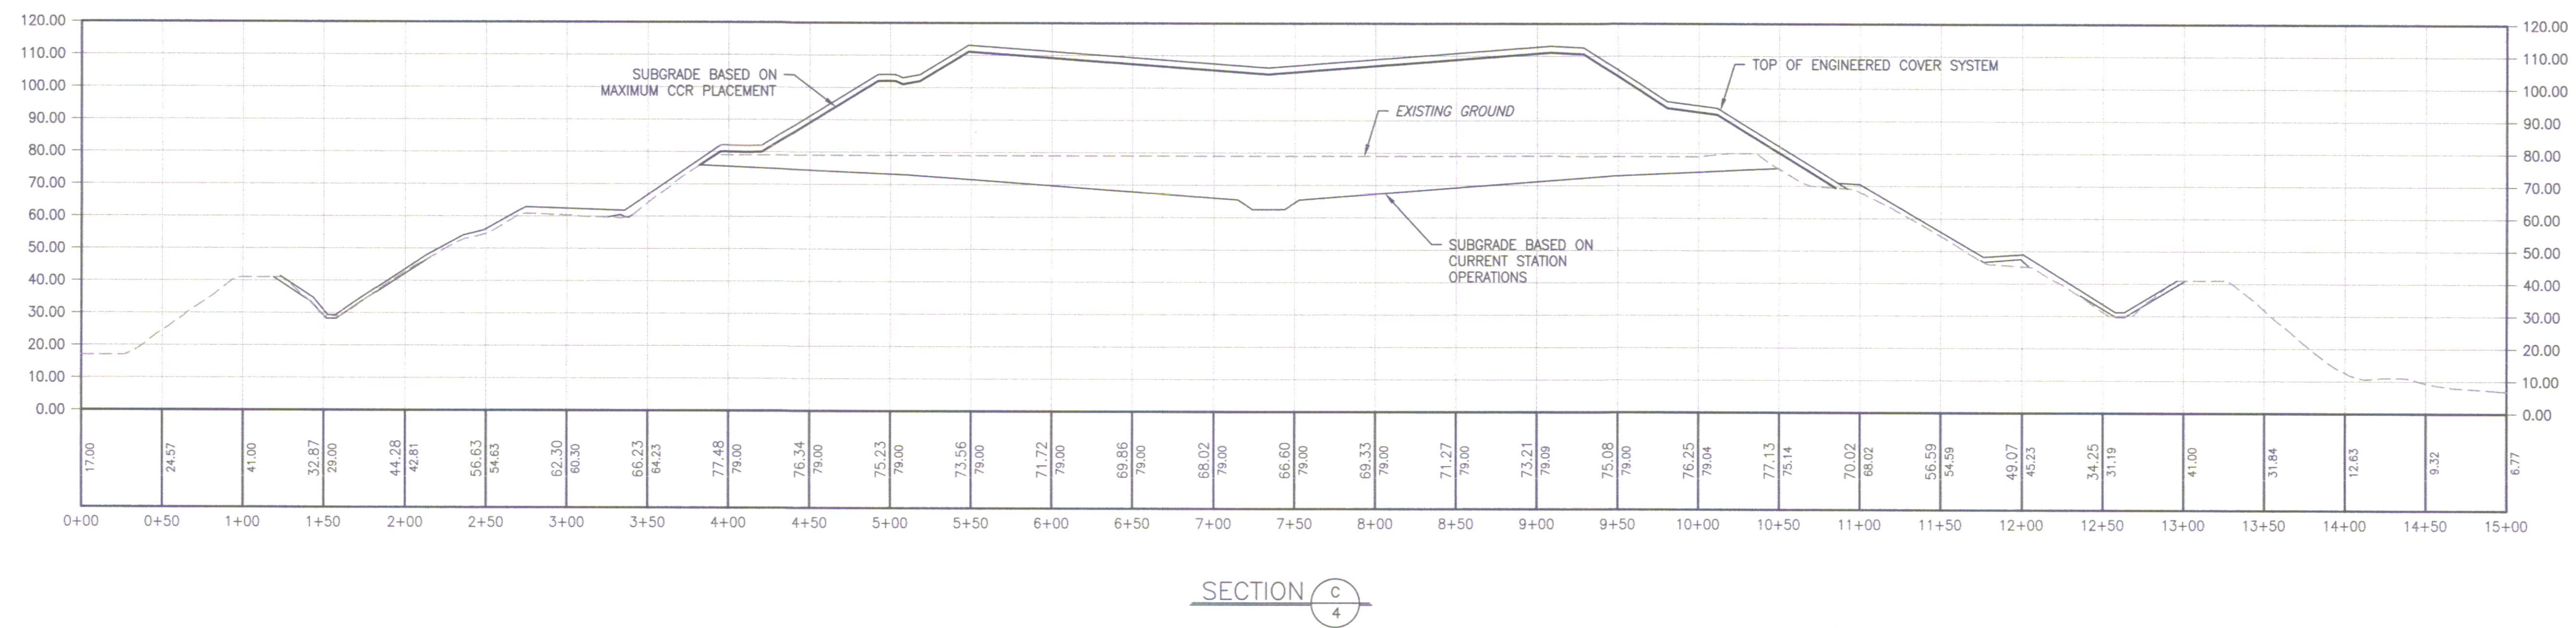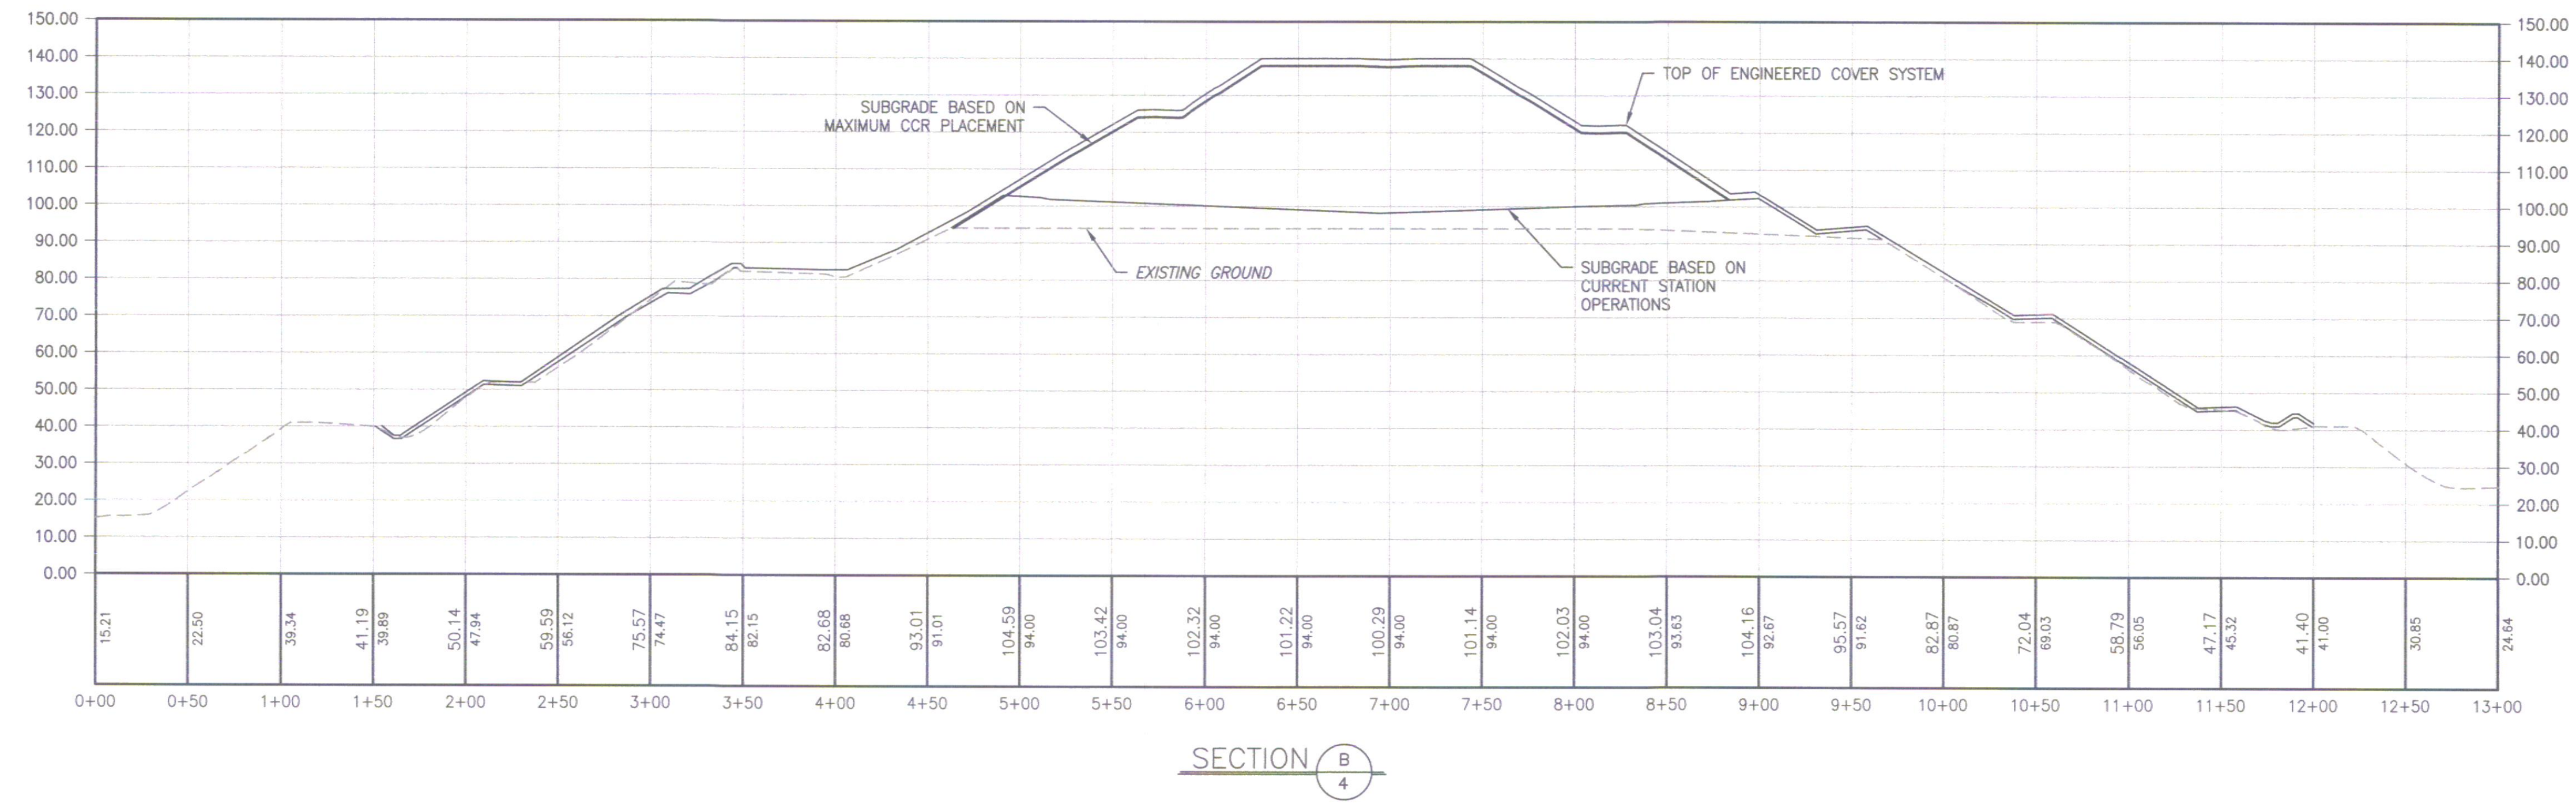VERTICAL SCALE: 1" = 30'

REVISION RECORD					
NO.	DATE	DWN.	CHK.	APV.	DESCRIPTION
A	1/7/2016	JDS	KMB	JDP	RELEASED FOR APPROVAL
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GA: CAD FILE PATH: Z:\Energy\2015\C150035-00 - DOM-Chesterfield Pond Closure\CAD\Permit\Production Drawings\C150035-00-000-00-C-E1-107.dwg PLOTTED ON: 1/7/2016 1:06:09 PM PLOTTED BY: Joe Neiman PLOT FILE: Galts					

DRAWING TITLE		
CROSS SECTIONS		
PROJECT		CLIENT
UPPER (EAST) POND CCR CLOSURE CHESTERFIELD POWER STATION CHESTERFIELD COUNTY, VIRGINIA		DOMINION GLEN ALLEN, VIRGINIA
ISSUING OFFICE: Pittsburgh 385 E. Waterfront Drive, Homestead, PA 15120		




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AS SHOWN		1/7/2016	
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	7 OF 10		C150035-00-000-00-C-E1-107

NOTES:


- WHERE SUBGRADE CONSISTS OF EXISTING GROUND, STRIP EXISTING VEGETATION AND PREPARE THE SUBGRADE SO THAT THE MATERIAL AT THE SURFACE IS FREE OF PROTRUDING ROCKS, FRACTURED STONE, DEBRIS, COBBLES, RUBBISH, ROOTS AND SUDDEN CHANGES IN SLOPE. A CUSHION GEOTEXTILE CAN BE PLACED OVER THE STRIPPED SUBGRADE IN LIEU OF SUBGRADE PREPARATION ACTIVITIES.
- THE CAP SYSTEM AND FINAL COVER SHALL BE COLLECTIVELY REFERRED TO AS THE ENGINEERED COVER SYSTEM.

CAP SYSTEM DETAIL 1
N.T.S. 3,8,9,10

NOTE: EROSION CONTROL MATTING WILL BE INSTALLED IN AREAS WITH SLOPES OF 3H:1V OR GREATER.

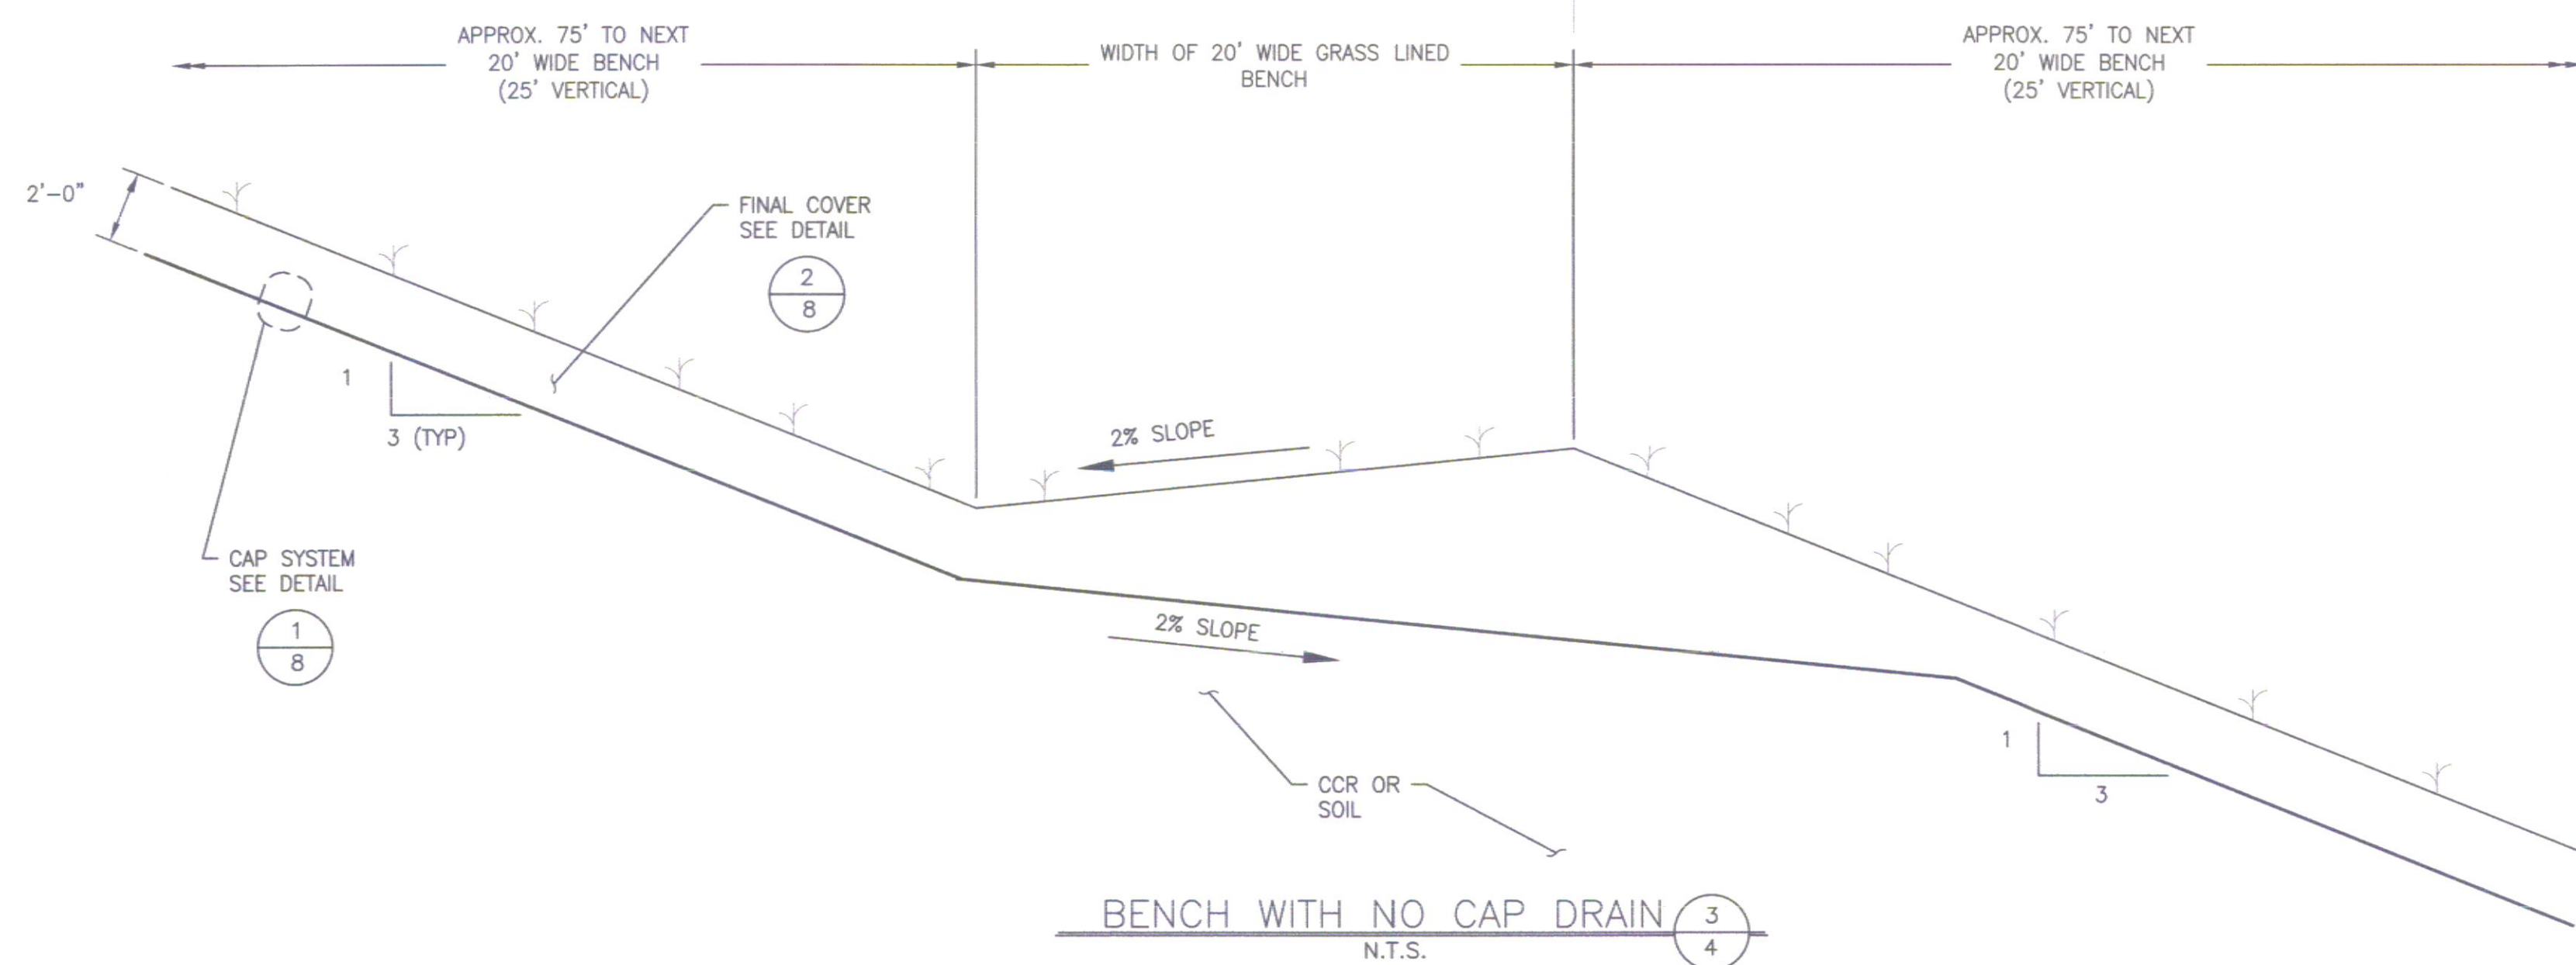

BENCH WITH NO CAP DRAIN 3
N.T.S. 4

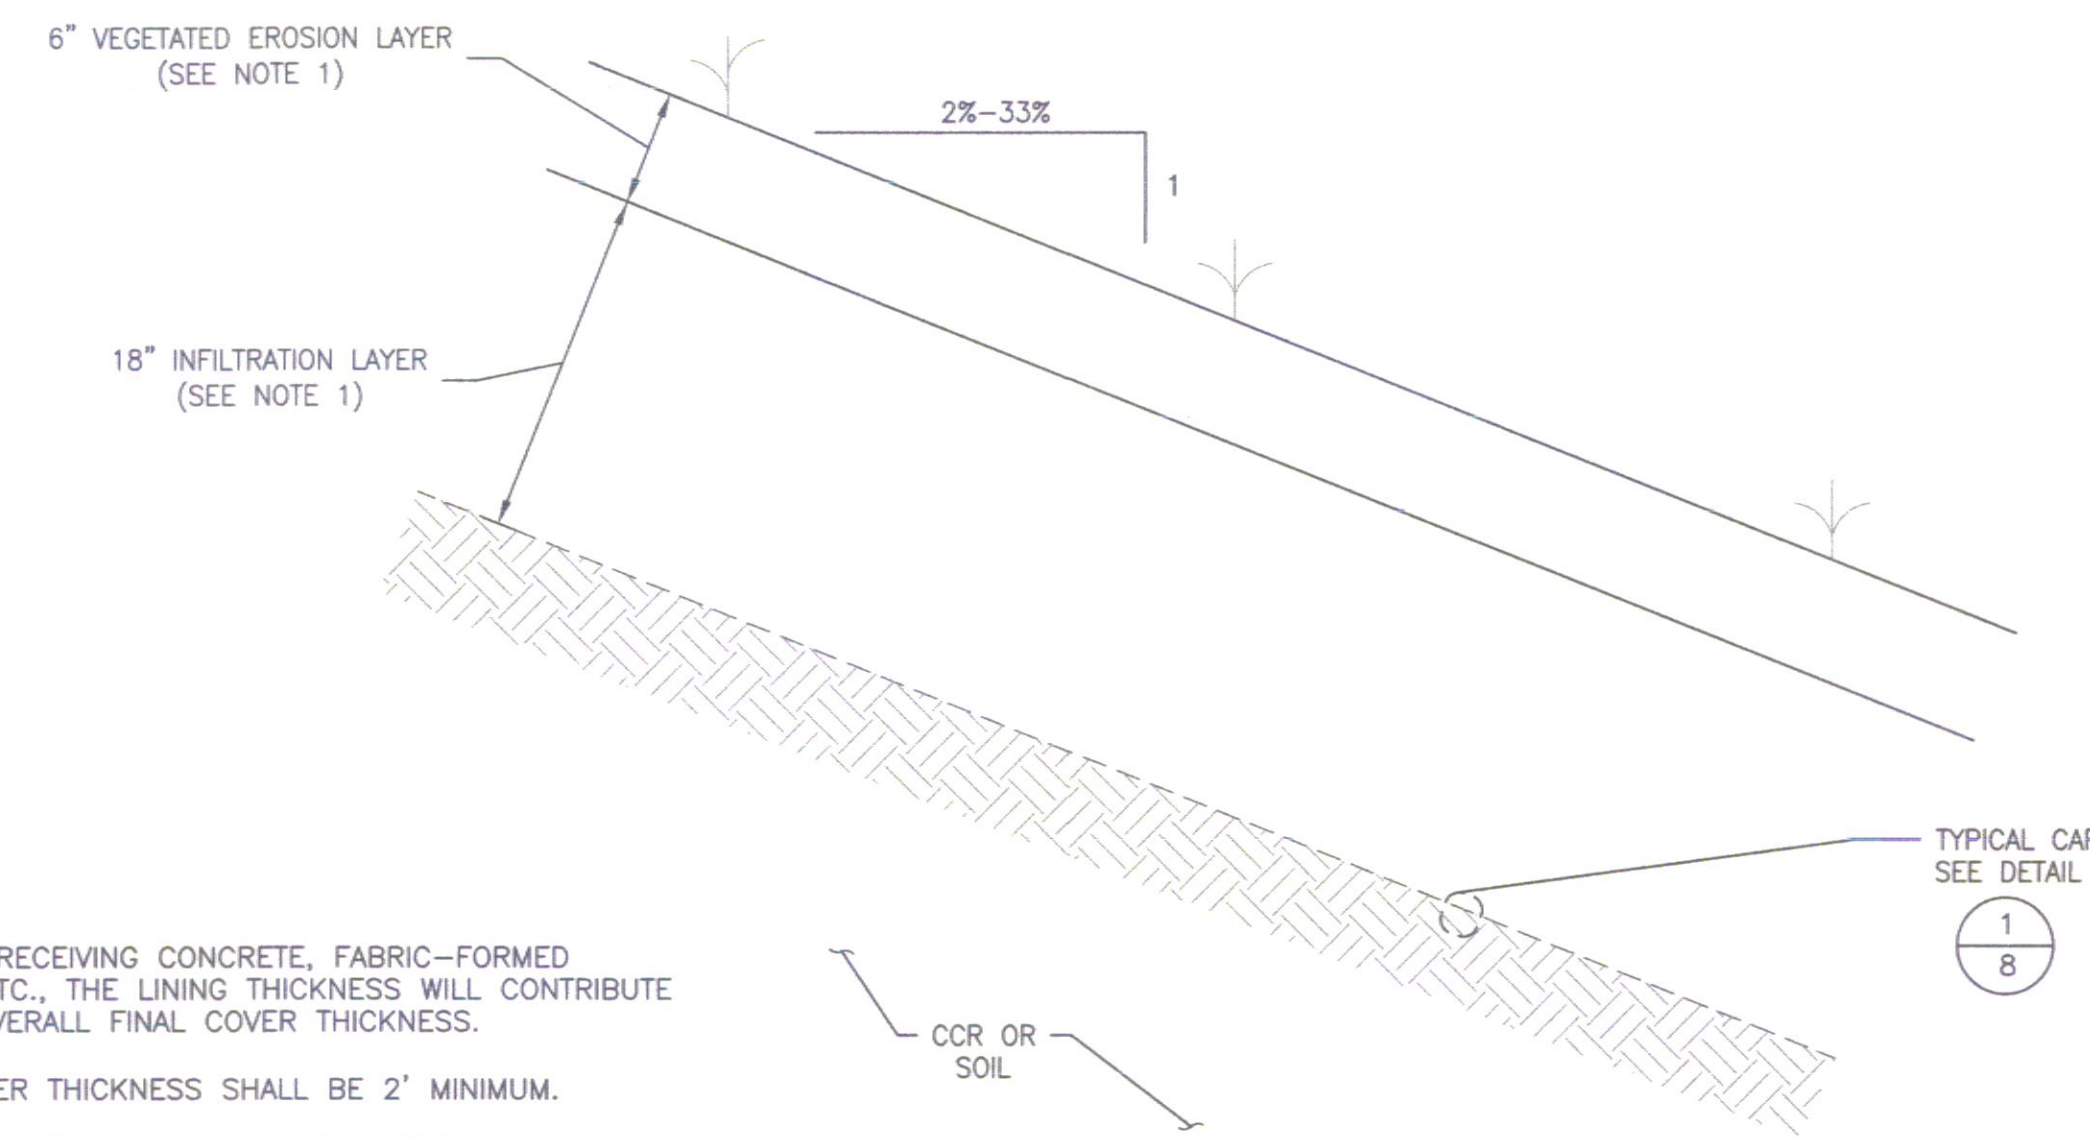


FINAL COVER 2
N.T.S. 4,8,9,10


NOTES:

- IN AREAS RECEIVING CONCRETE, FABRIC-FORMED LININGS, ETC., THE LINING THICKNESS WILL CONTRIBUTE TO THE OVERALL FINAL COVER THICKNESS.
- FINAL COVER THICKNESS SHALL BE 2' MINIMUM.
- THE CAP SYSTEM AND FINAL COVER SHALL BE COLLECTIVELY REFERRED TO AS THE ENGINEERED COVER SYSTEM.

NOTE: 1. EROSION CONTROL MATTING WILL BE INSTALLED IN AREAS WITH SLOPES OF 3H:1V OR GREATER.

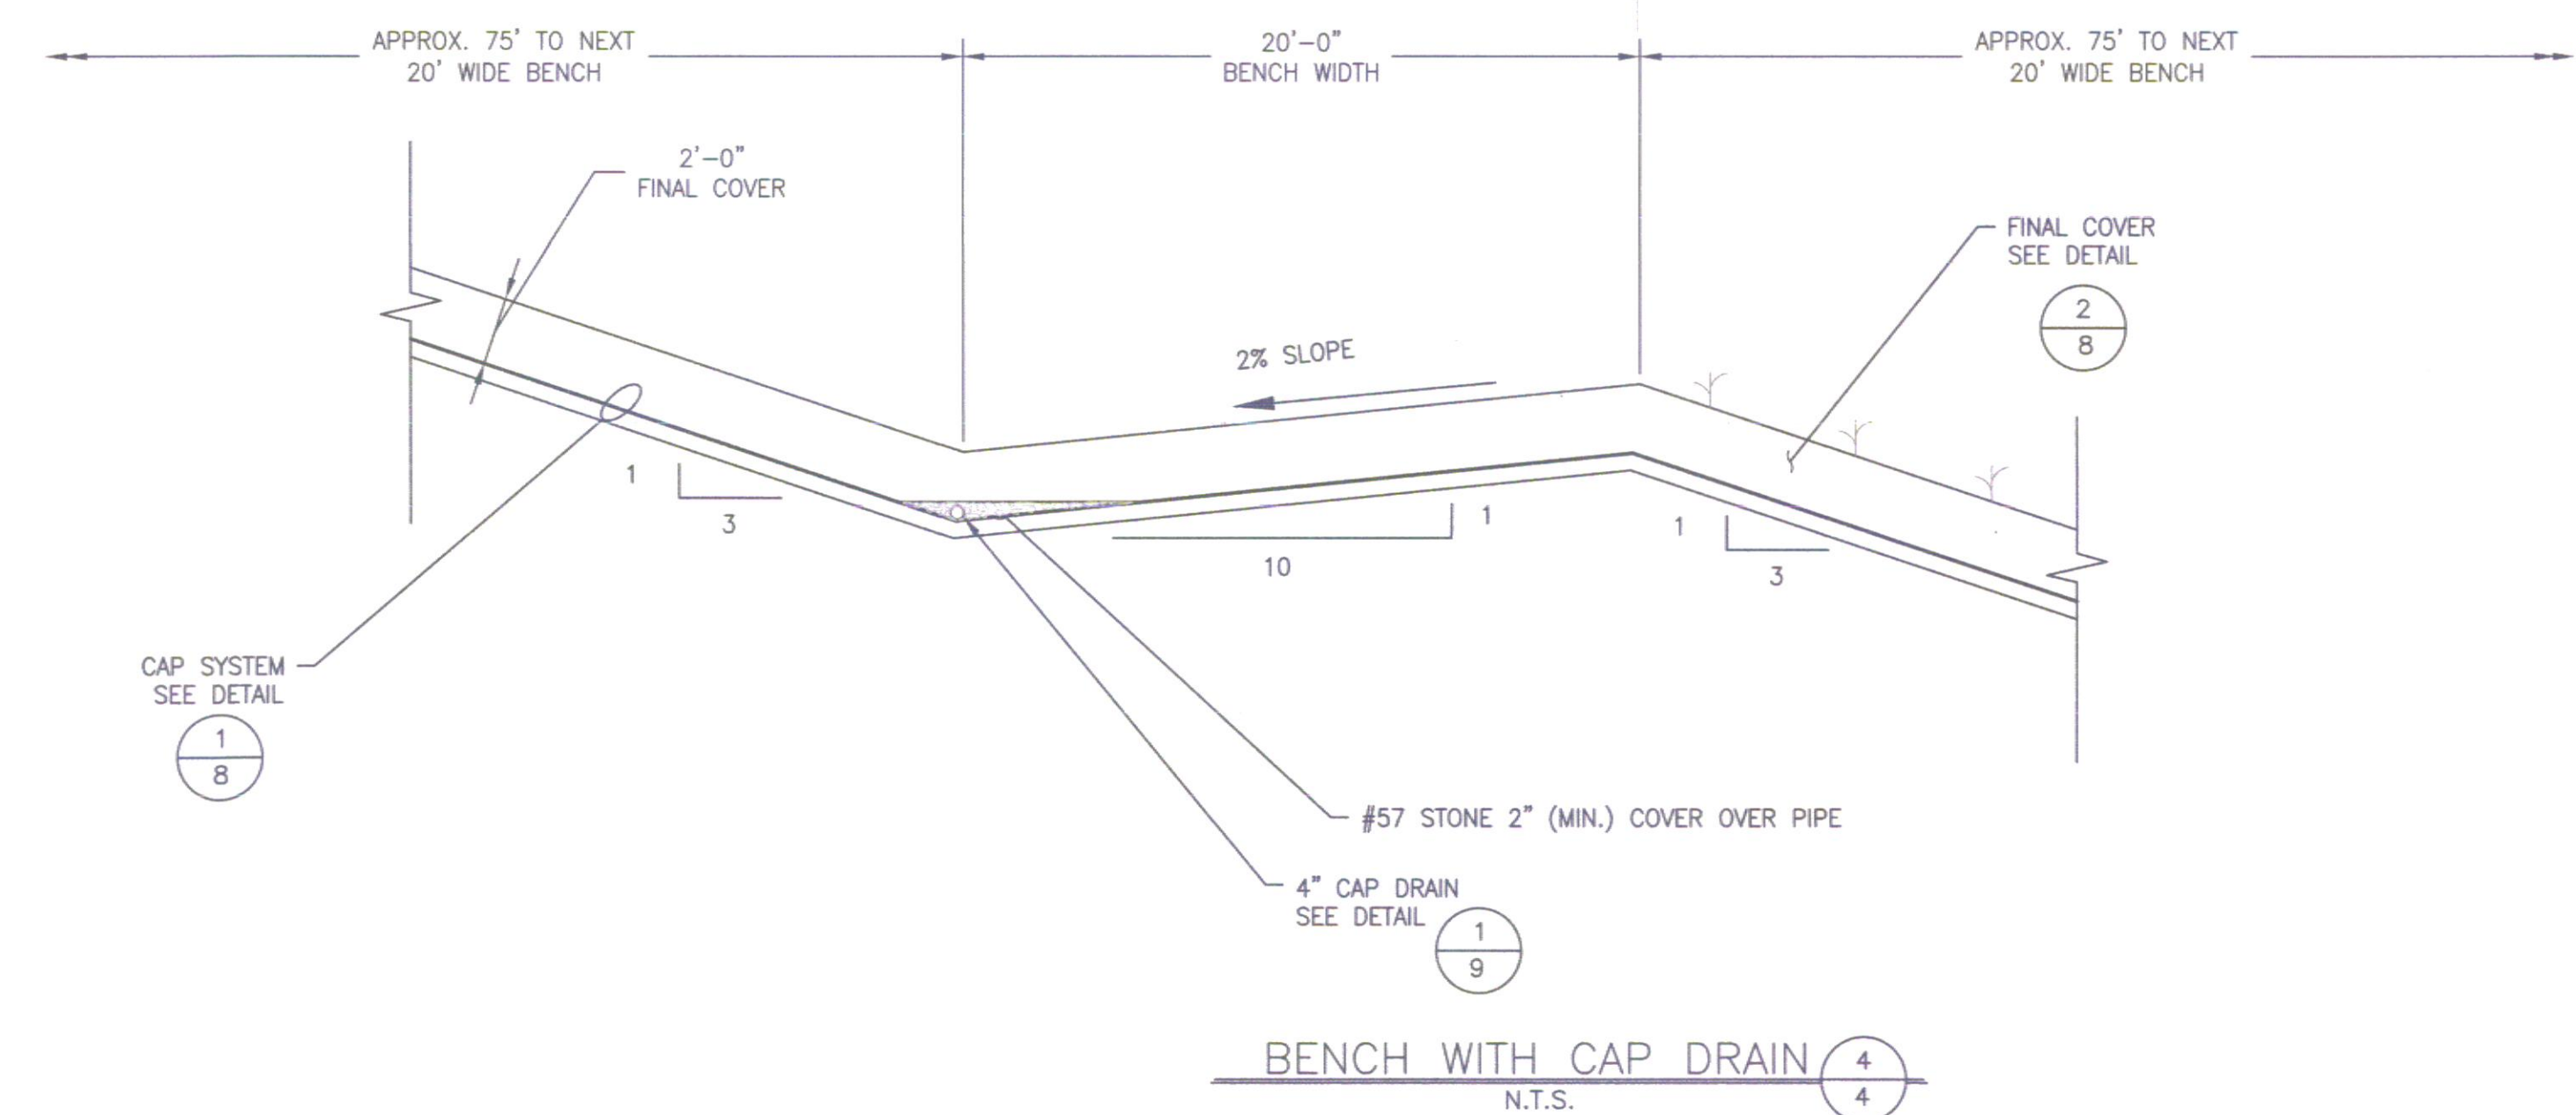

BENCH WITH CAP DRAIN 4
N.T.S. 4

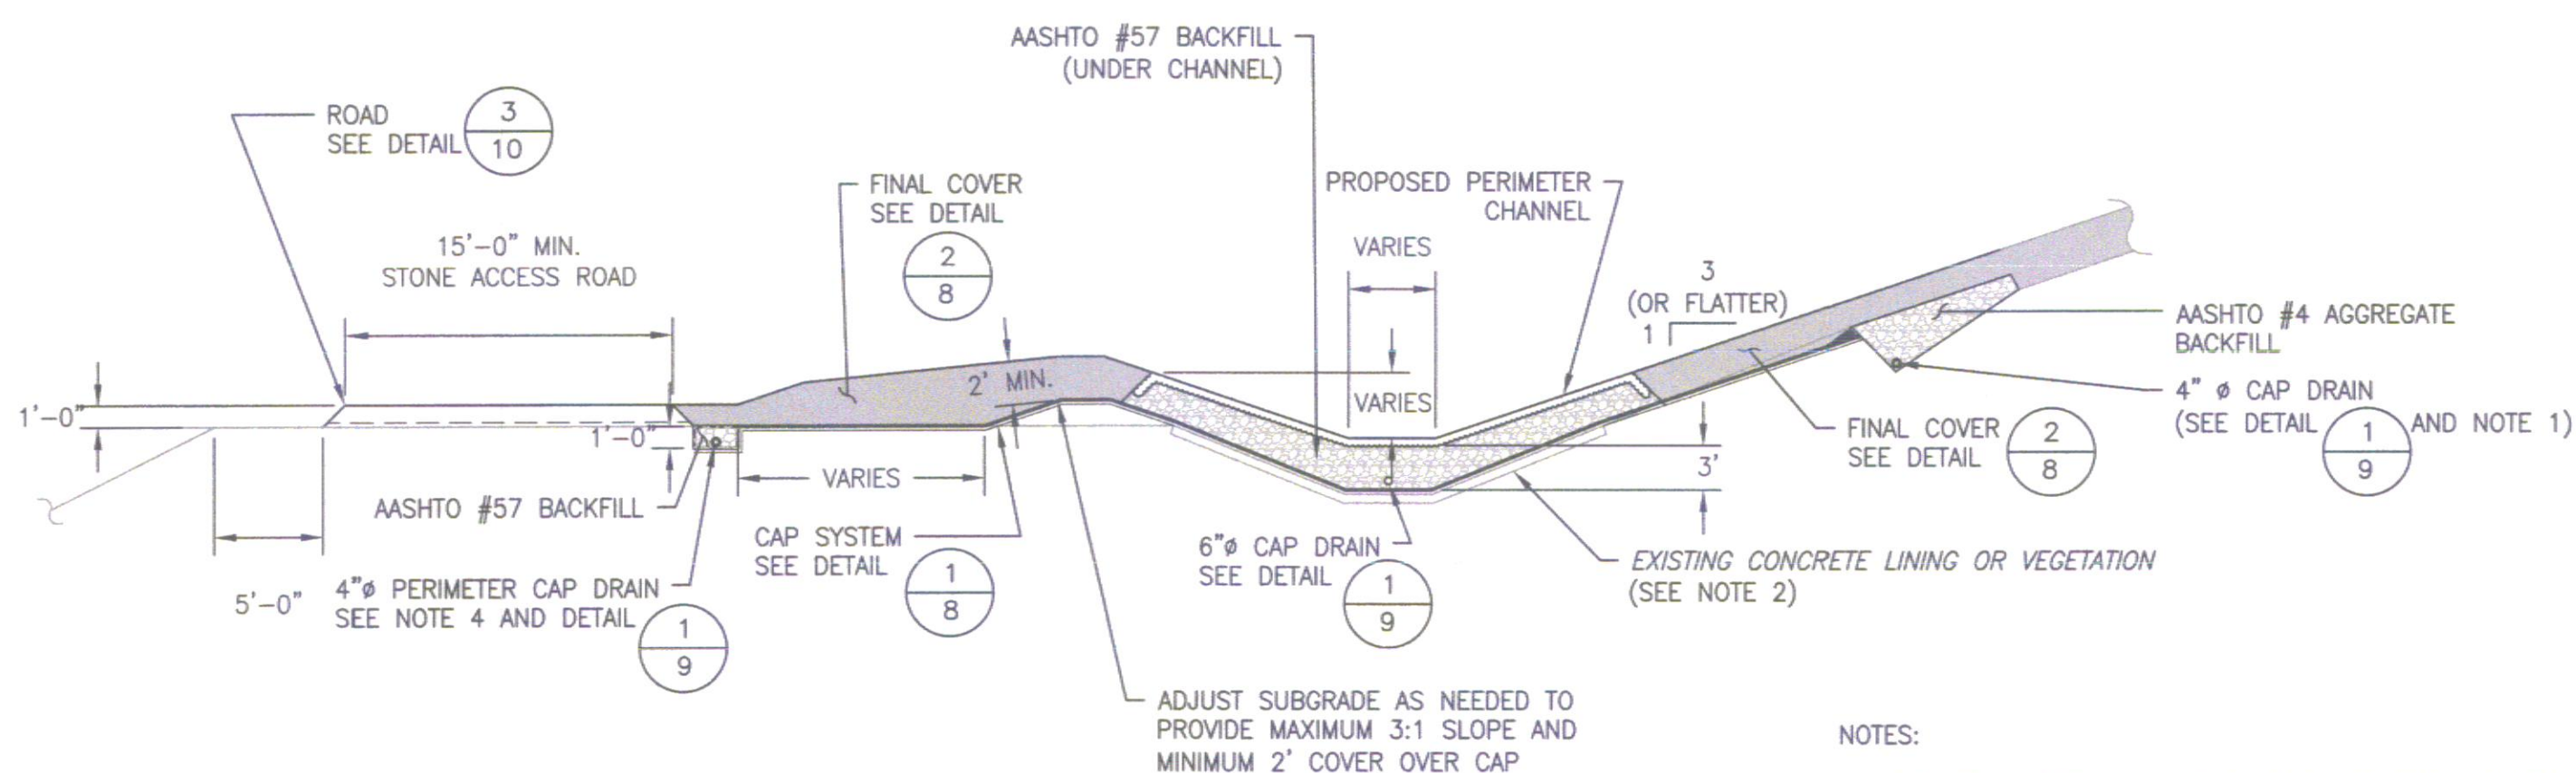


CHANNEL ABOVE DIKE GRADE
N.T.S.


NOTES:

- CAP DRAIN PIPE SHALL DISCHARGE INTO THE CAP DRAIN PIPES CONVEYED BENEATH SLOPE DRAINS.
- EVERY 50 LONGITUDINAL FEET DRILL A 1-INCH DIAMETER HOLE THROUGH THE EXISTING CONCRETE CHANNEL AND 6 INCHES INTO THE SUBGRADE TO PROVIDE RELIEF FOR WATER BETWEEN THE CONCRETE AND THE CAP.
- FENCING, UNDERGROUND ELECTRIC, AND OTHER UTILITIES ARE LOCATED ALONG THE TOP OF THE POND DIKE. ANY ITEMS THAT ARE DAMAGED OR DISTURBED SHALL BE REPAIRED OR REPLACED AT THE OWNER'S DIRECTION.
- THE PERIMETER CAP DRAIN WILL BE AT CONSTANT ELEVATION UNTIL CONVERGING WITH THE CAP DRAIN BENEATH THE CHANNEL.

CAP AND COVER PERIMETER CHANNEL 5
N.T.S. 3,4

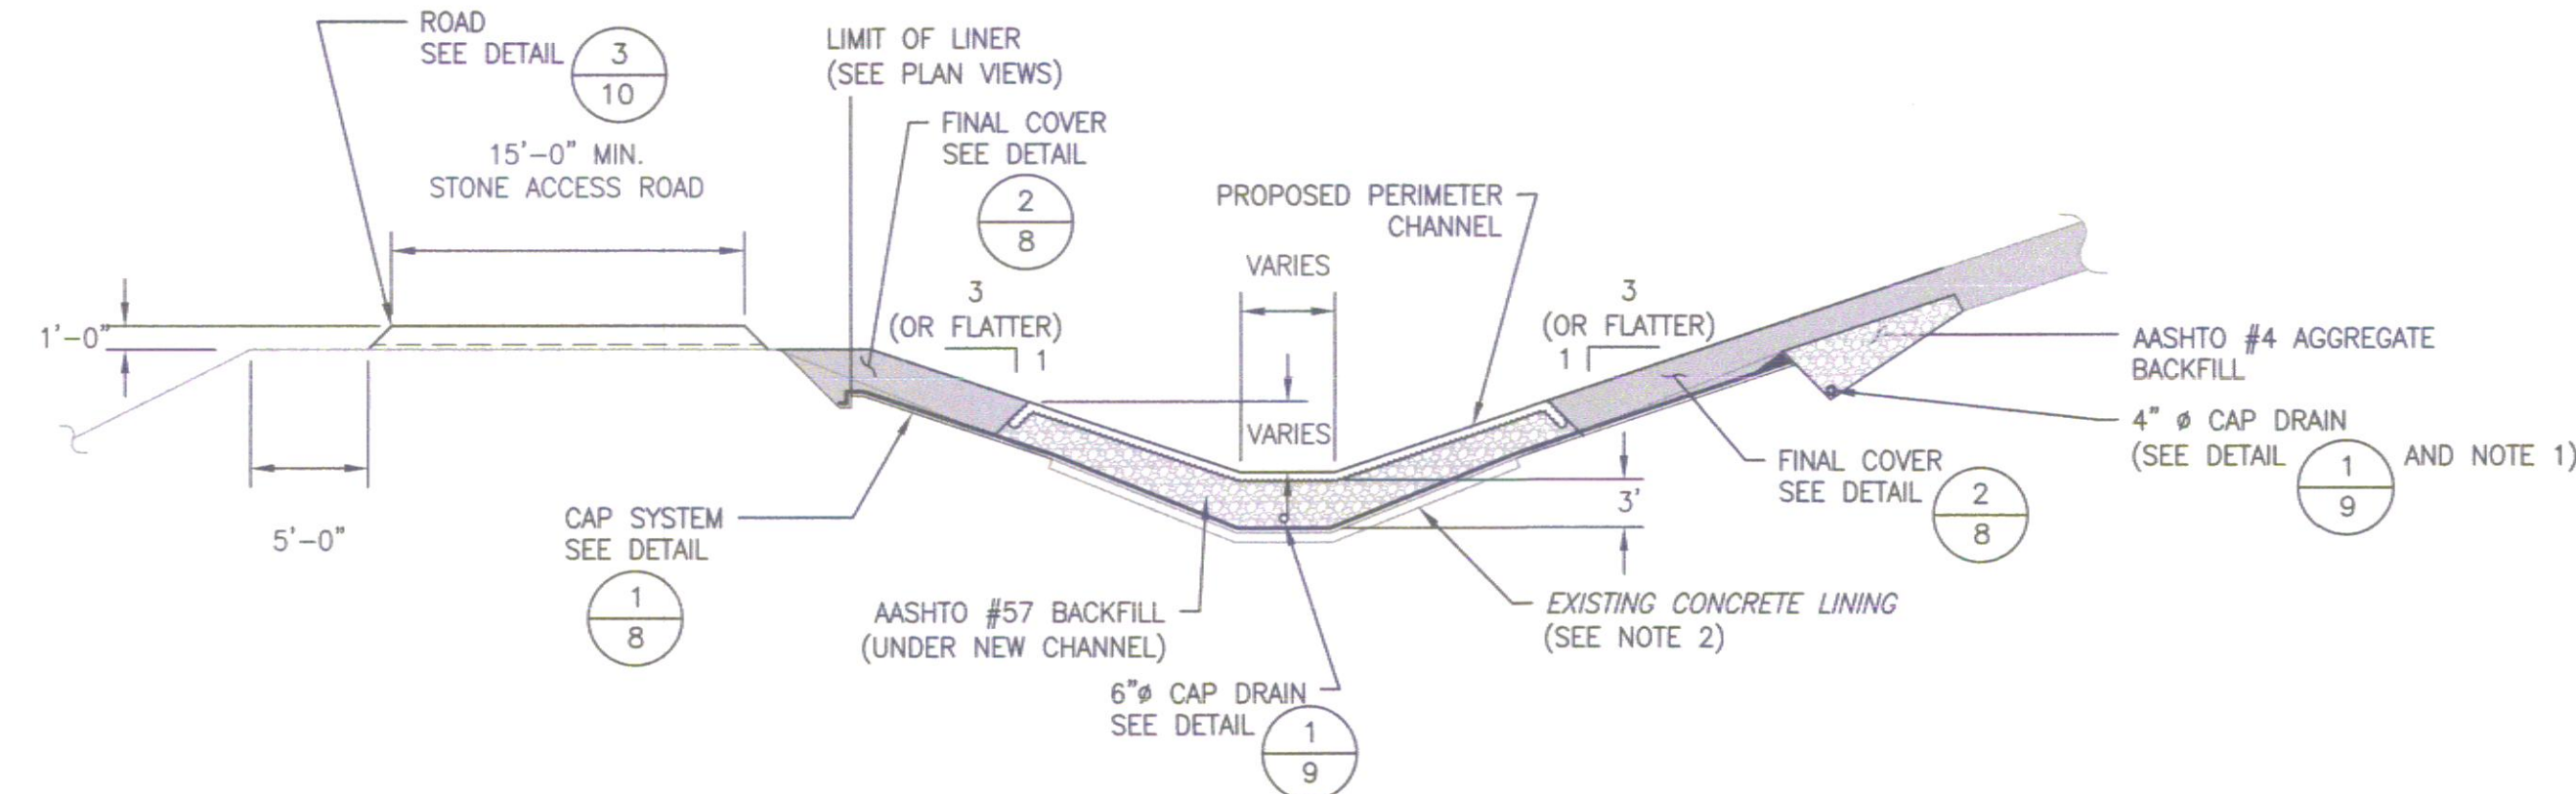

CHANNEL BELOW DIKE GRADE
N.T.S.

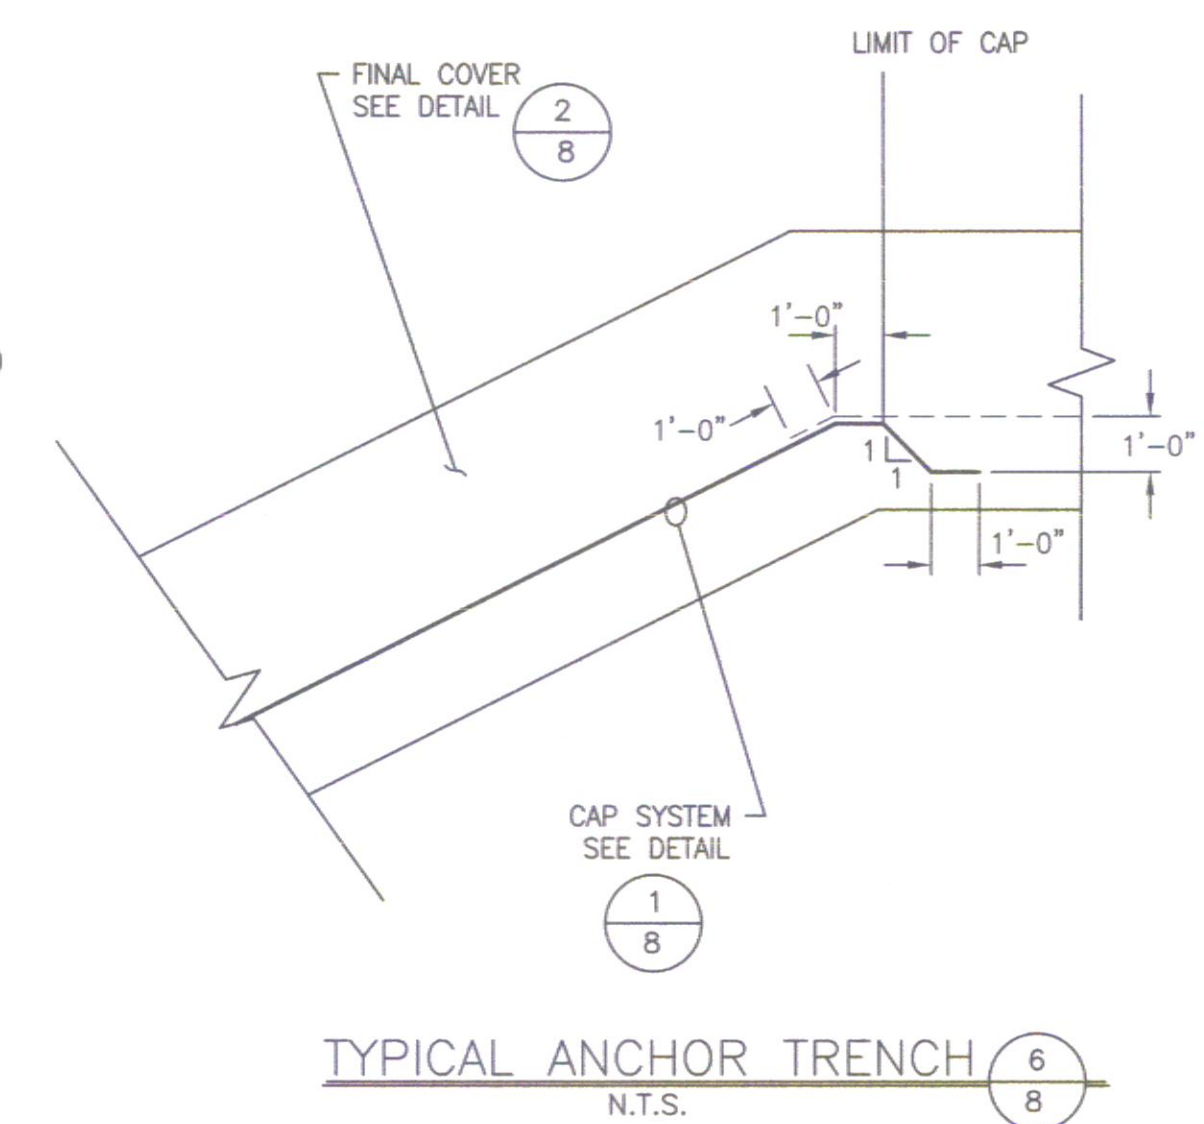


TYPICAL ANCHOR TRENCH 6
N.T.S. 8

NOTES:


- ANCHOR TRENCH SHALL BE INSTALLED PRIOR TO PLACEMENT OF FINAL COVER.

NO.	DATE	DWN	CHK	APV	DESCRIPTION
A	1/7/2016	WJH	KMB	JDP	RELEASED FOR APPROVAL
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GAI CAD FILE PATH: Z:\Energy\2015\C150035-00 - DOM-Chesterfield Pond Closure\CAD\Permit\Production Drawings\C150035-00-000-00-C-E1-108.dwg PLOTTED ON: 1/7/2016 1:10:20 PM PLOTTED BY: Joe Neiman PLOT FILE: GAI.sbt					

DRAWING TITLE		
CAP AND COVER DETAILS		
PROJECT	CLIENT	
UPPER (EAST) POND CCR CLOSURE	DOMINION	
CHESTERFIELD POWER STATION	GLEN ALLEN, VIRGINIA	
CHESTERFIELD COUNTY, VIRGINIA		
ISSUING OFFICE: Pittsburgh 385 E. Waterfront Drive, Homestead, PA 15120		

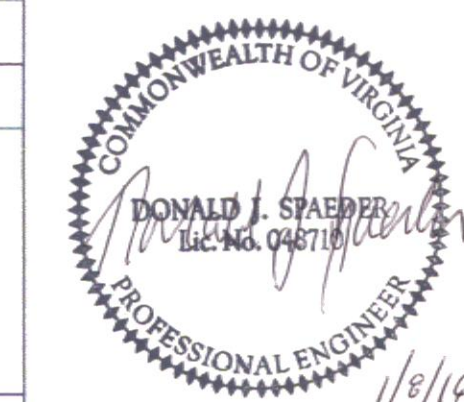

DRAWN BY:	CHECKED BY:	APPROVED BY:	GAI FILE NUMBER:
HARRIWJ	BORTZKM	PHILLJD	C150035-00-000-00-C-E1-108
DWG TYPE:	SCALE:	ISSUE DATE:	ALT./CLIENT DRAWING NUMBER:
AS SHOWN		1/7/2016	
REVISION	SHEET NO.:	GAI DRAWING NUMBER:	
A	8 OF 10	C150035-00-000-00-C-E1-108	

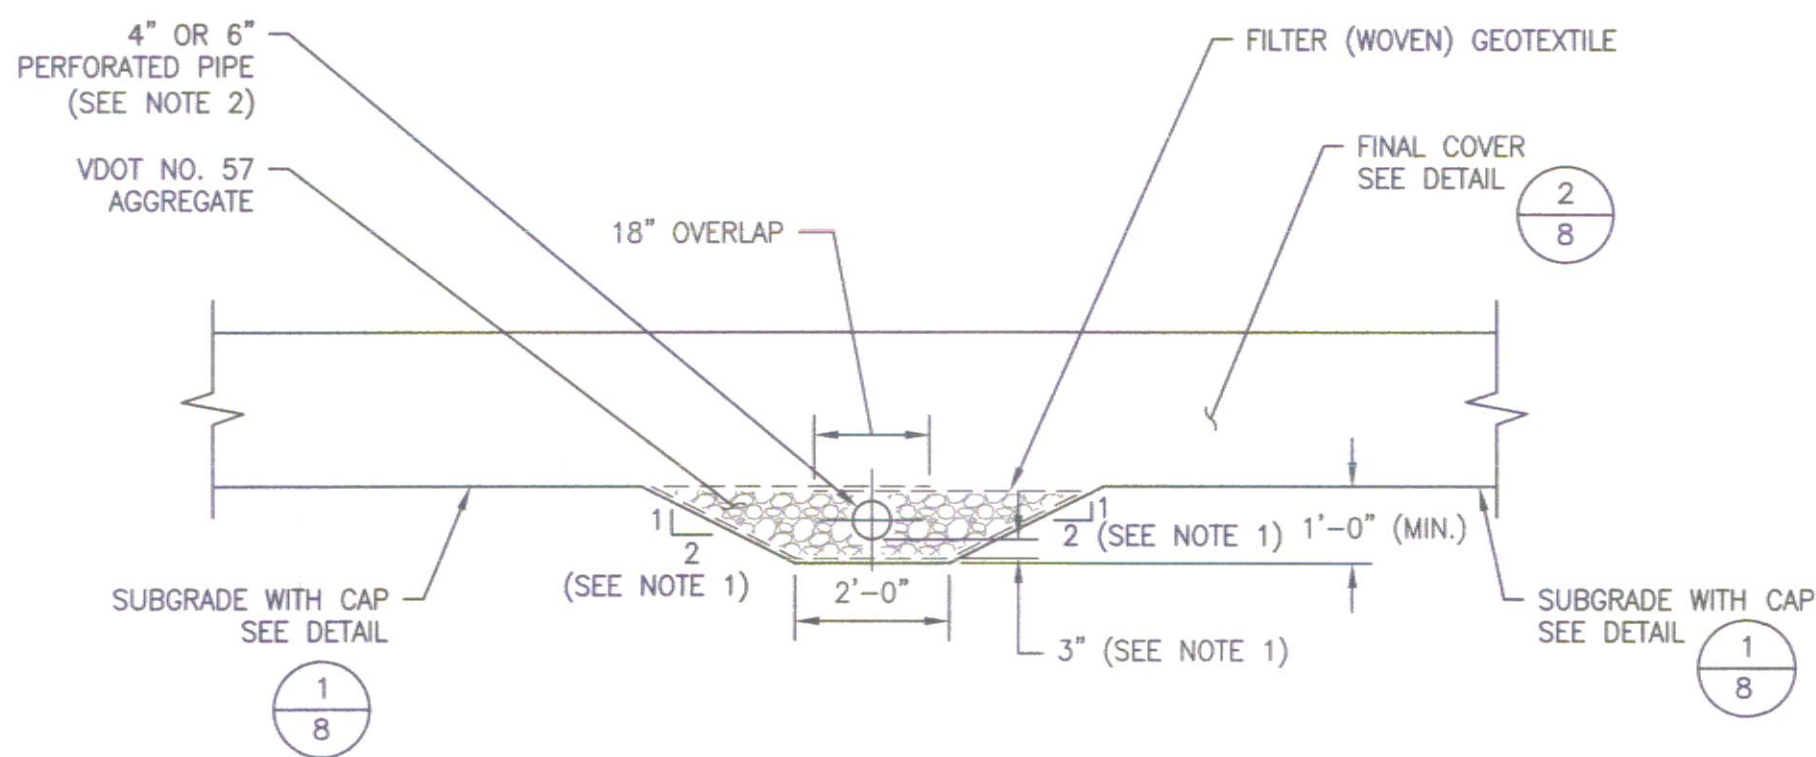


CAP DRAINS 1
N.T.S. 3,8


NOTES:

1. THE TOPOGRAPHY SHOWN IS FOR CAP DRAIN LATERALS. CAP DRAINS BENEATH CHANNELS AND SLOPE DRAINS WILL BE CONSTRUCTED TO THE SAME CONFIGURATION. THE 2:1 SLOPE WILL BE EXTENDED AS NEEDED TO MEET SUBGRADE.
2. PIPE SHALL BE 6" UNDER ALL CHANNELS, SLOPE DRAINS, AND SPILLWAYS AND 4" AT ALL OTHER LOCATIONS UNLESS NOTED OTHERWISE. PIPE SHALL BE ADS N-12 SOIL-TIGHT HDPE PIPE OR APPROVED EQUIVALENT UNLESS OTHERWISE NOTED. CAP DRAIN SHALL BE PERFORATED ACCORDING TO DETAIL UNLESS OTHERWISE NOTED.
3. CLEANOUTS WILL BE PROVIDED AT SELECT LOCATIONS.

2
9

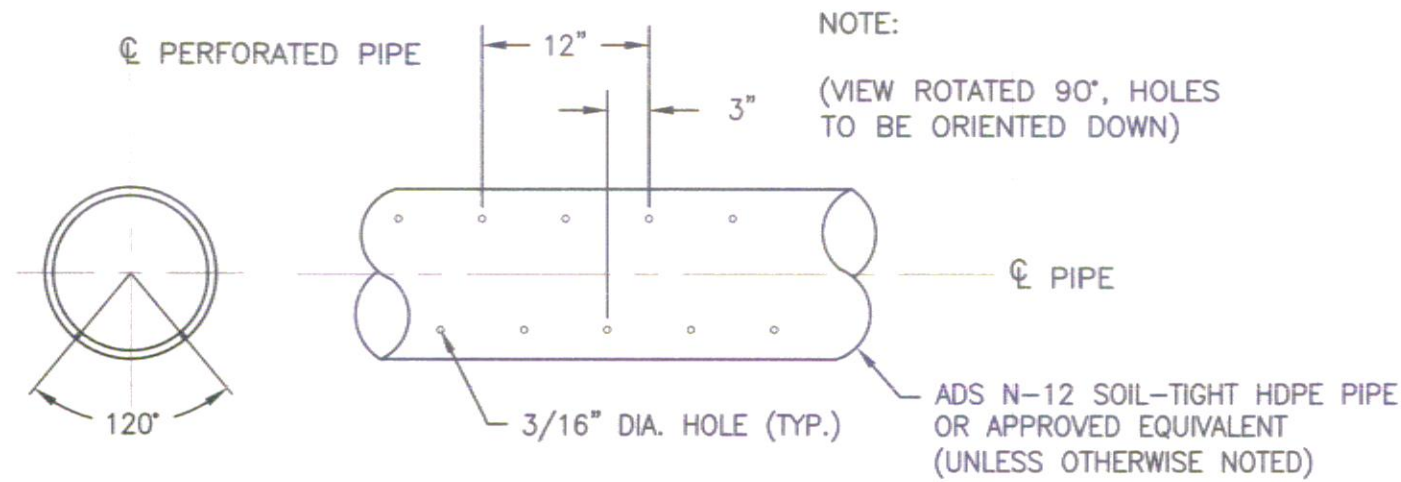


PIPE PERFORATION PATTERNS 2
N.T.S. 9

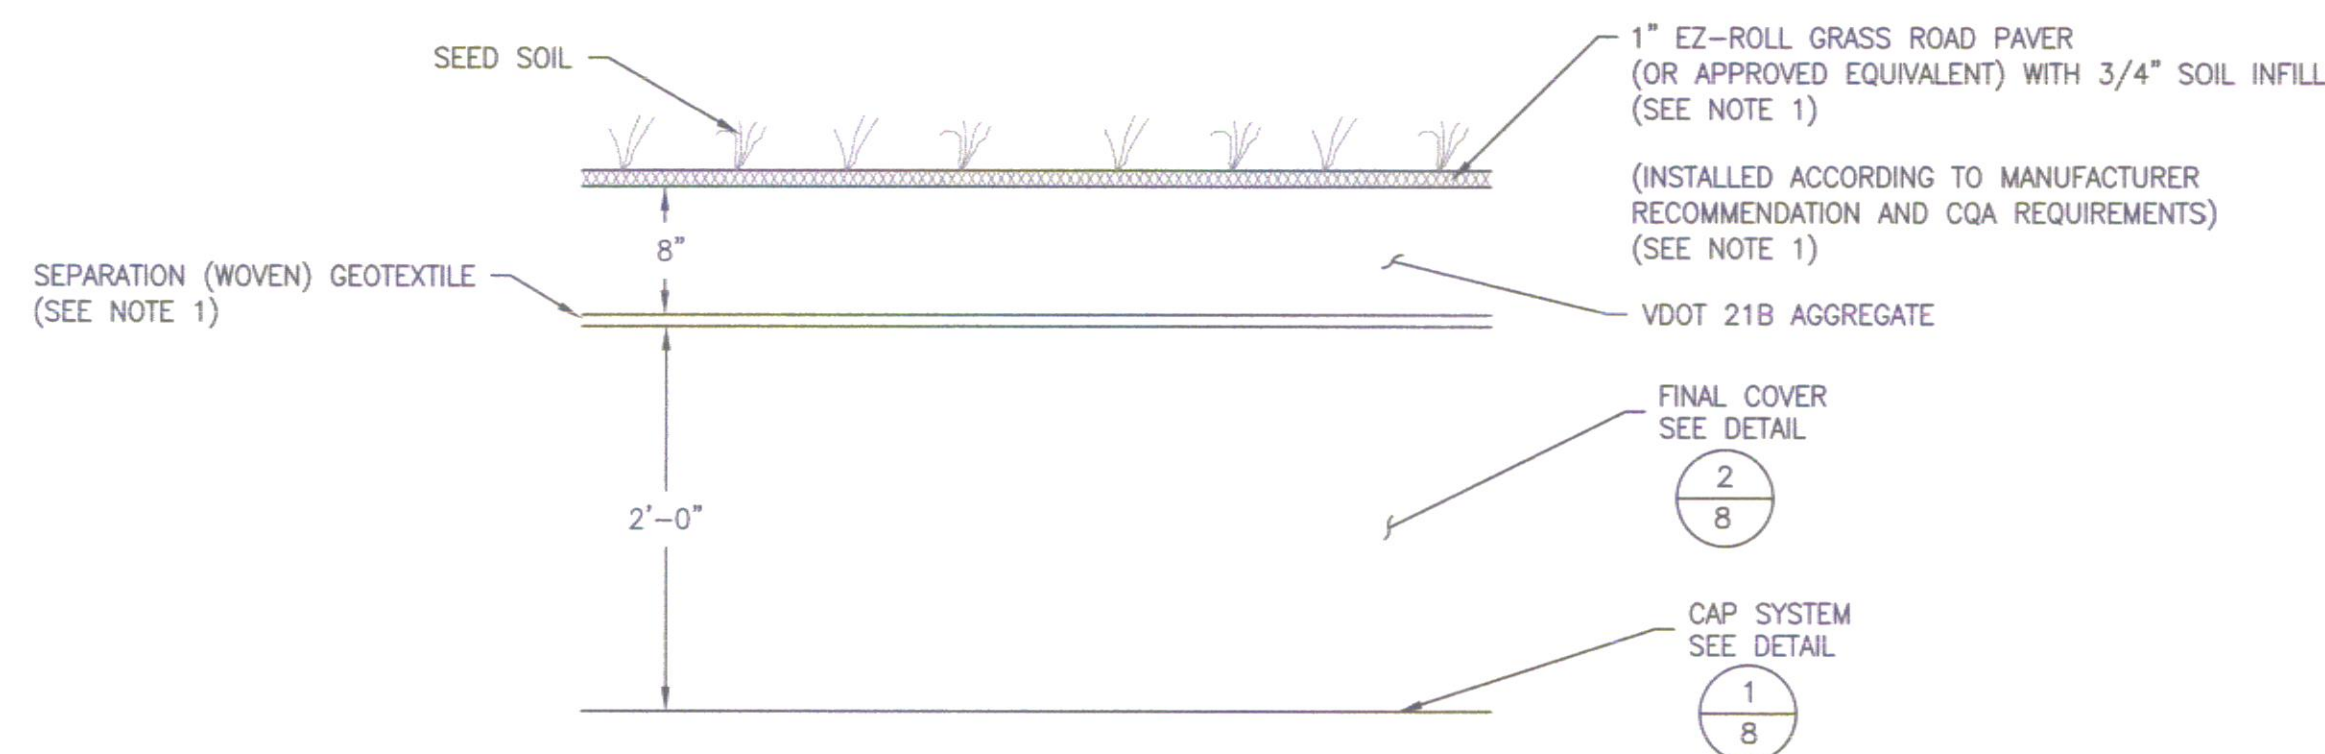

ALTERNATE FINAL COVER: PUBLIC OVERFLOW PARKING AREA DETAIL 4
N.T.S. 4

NOTE:

1. THIS DETAIL IS TO BE USED AS AN ALTERNATE FINAL COVER WHERE OVERFLOW PARKING IS TO BE UTILIZED.
2. THE CAP SYSTEM AND FINAL COVER SHALL BE COLLECTIVELY REFERRED TO AS THE ENGINEERED COVER SYSTEM.

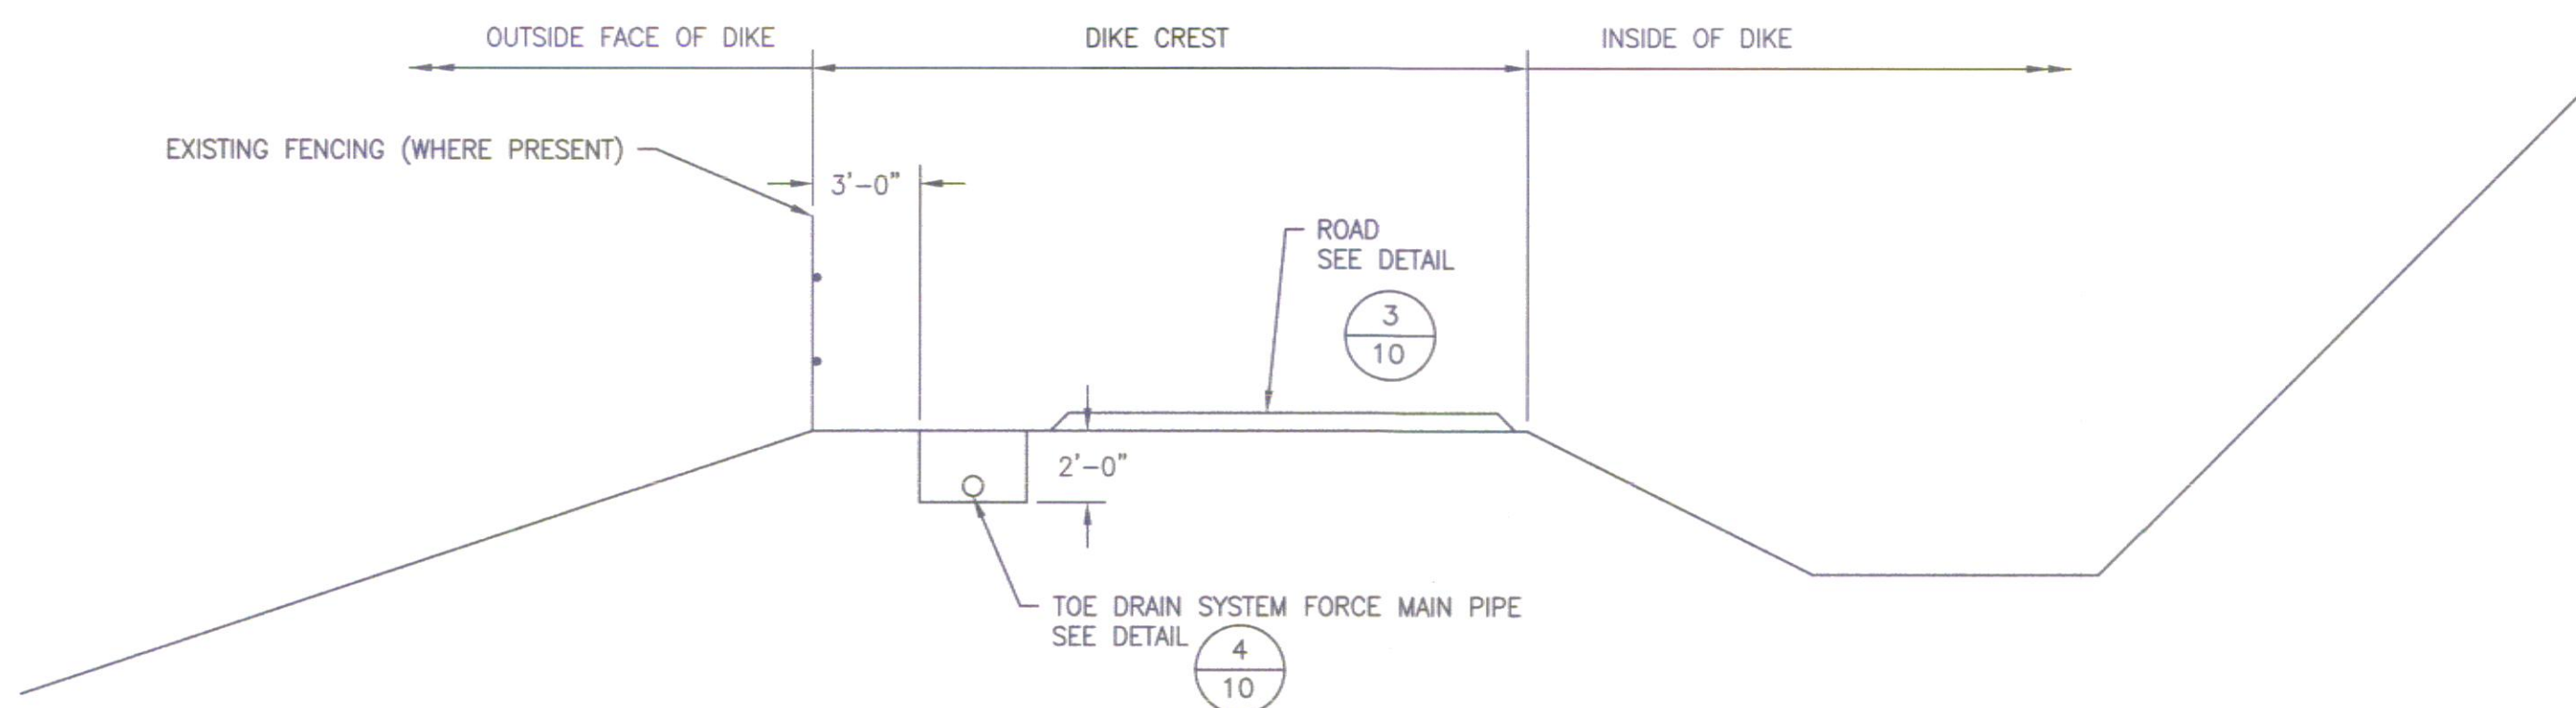


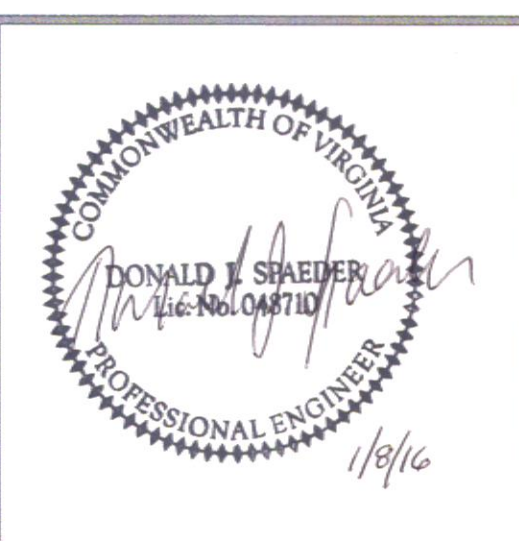
NOTES:

1. REPAIR OR REPLACE ANY FENCING DAMAGED OR OTHERWISE IMPACTED DURING CONSTRUCTION.


TOE DRAIN SYSTEM FORCE MAIN LOCATION ON DIKE TOP 3
N.T.S. 4

A	1/7/2016	WJH	KMB	JDP	RELEASED FOR APPROVAL
NO.:	DATE:	DWN:	CHK:	APV:	DESCRIPTION:
REVISION RECORD					
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GAI CAD FILE PATH: Z:\Energy\2015\C150035-00 - DOM-Chesterfield Pond Closure\CAD\Permit\Production Drawings\C150035-00-000-00-C-E1-109.dwg PLOTTED ON: 1/7/2016 1:24:43 PM PLOTTED BY: Joe Neilman PLOT FILE: GA1a1b					

DRAWING TITLE		
CAP DRAIN, FORCE MAIN, AND PARKING DETAILS		
PROJECT		CLIENT
UPPER (EAST) POND CCR CLOSURE CHESTERFIELD POWER STATION CHESTERFIELD COUNTY, VIRGINIA		DOMINION GLEN ALLEN, VIRGINIA
ISSUING OFFICE: Pittsburgh 385 E. Waterfront Drive, Homestead, PA 15120		



DRAWN BY:	CHECKED BY:	APPROVED BY:	GAI FILE NUMBER:
HARRIWJ	BORTZKM	PHILLJD	C150035-00-000-00-C-E1-109
DWG TYPE:	SCALE:	ISSUE DATE:	ALT./CLIENT DRAWING NUMBER:
	AS SHOWN	1/7/2016	
REVISION	SHEET NO.:	GAI DRAWING NUMBER:	
A	9 OF 10	C150035-00-000-00-C-E1-109	

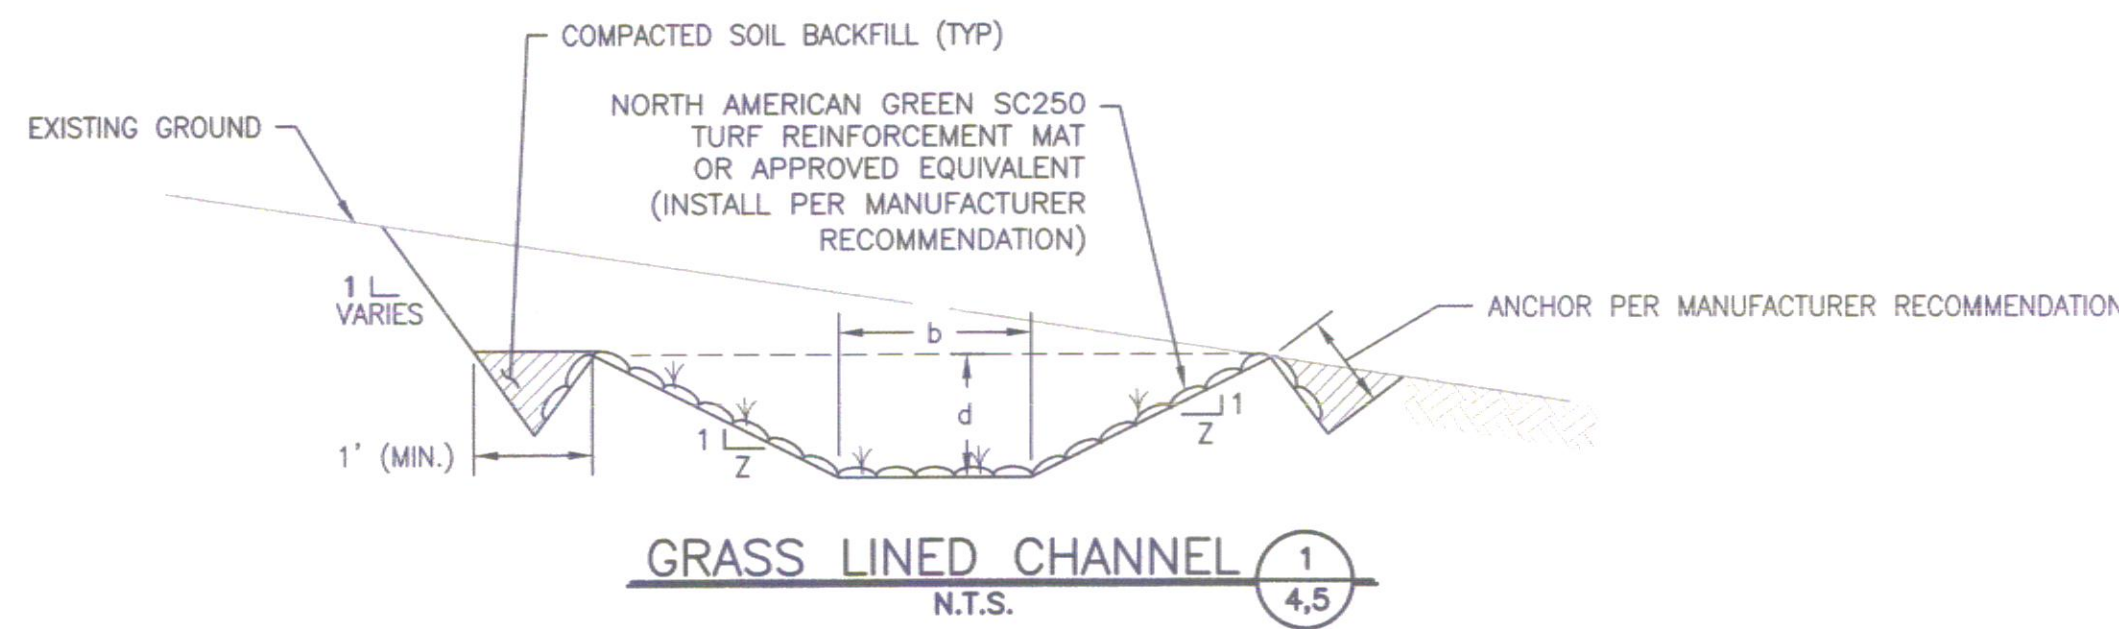


GRASS LINED CHANNEL 1/4,5
N.T.S.

CHANNEL SCHEDULE				
CHANNEL ID	LINING	BOTTOM WIDTH, b (FT)	DEPTH, d (FT)	SIDE SLOPES, z
NORTH 1	FABRIC-FORMED CONCRETE (4" USM)	3	2.25	3
NORTH 2	FABRIC-FORMED CONCRETE (4" USM)	4	2.5	3
NORTH 3	FABRIC-FORMED CONCRETE (4" USM)	5	3.25	3
SOUTH 1	FABRIC-FORMED CONCRETE (4" USM)	3	2.5	3
SOUTH 2	FABRIC-FORMED CONCRETE (4" USM)	3	3	3
SOUTH 3	FABRIC-FORMED CONCRETE (4" USM)	3	3.25	3
SOUTH 4	FABRIC-FORMED CONCRETE (4" USM)	4	3.75	3
CENTER, USM	FABRIC-FORMED CONCRETE (6" USM)	20	2.25	3
CENTER, GRASS	GRASS (WITH TURF REINFORCEMENT MAT)	0	2.25	38
SPILLWAY APPROACH	FABRIC-FORMED CONCRETE (8" USM)	55	3	3
SLOPE DRAINS	FABRIC-FORMED CONCRETE (4" USM)	2.25	1.5	3
WEST HAUL ROAD AND EAST ACCESS ROAD	FABRIC-FORMED CONCRETE (4" USM)	2	1	3
SEDIMENT POND DIVERSION	GRASS (WITH TURF REINFORCEMENT MAT)	5	TO GROUND SURFACE	3
AREA 1 DIVERSION	GRASS (WITH TURF REINFORCEMENT MAT)	3	1.75	2

CHANNEL SCHEDULE NOTES:


- USM = UNIFORM SECTION MAT.
- ALL CHANNEL LINING PROTECTION AND DIMENSIONS SHALL BE CONSIDERED MINIMUM FINISHED DIMENSIONS WITH LINING.
- LINING MATERIALS/MANUFACTURERS MAY BE SUBSTITUTED WITH AN APPROVED EQUIVALENT, WITH OWNER'S APPROVAL.
- CHANNEL SIZES ARE BASED ON CLOSURE GRADING USING CURRENT STATION OPERATIONS.

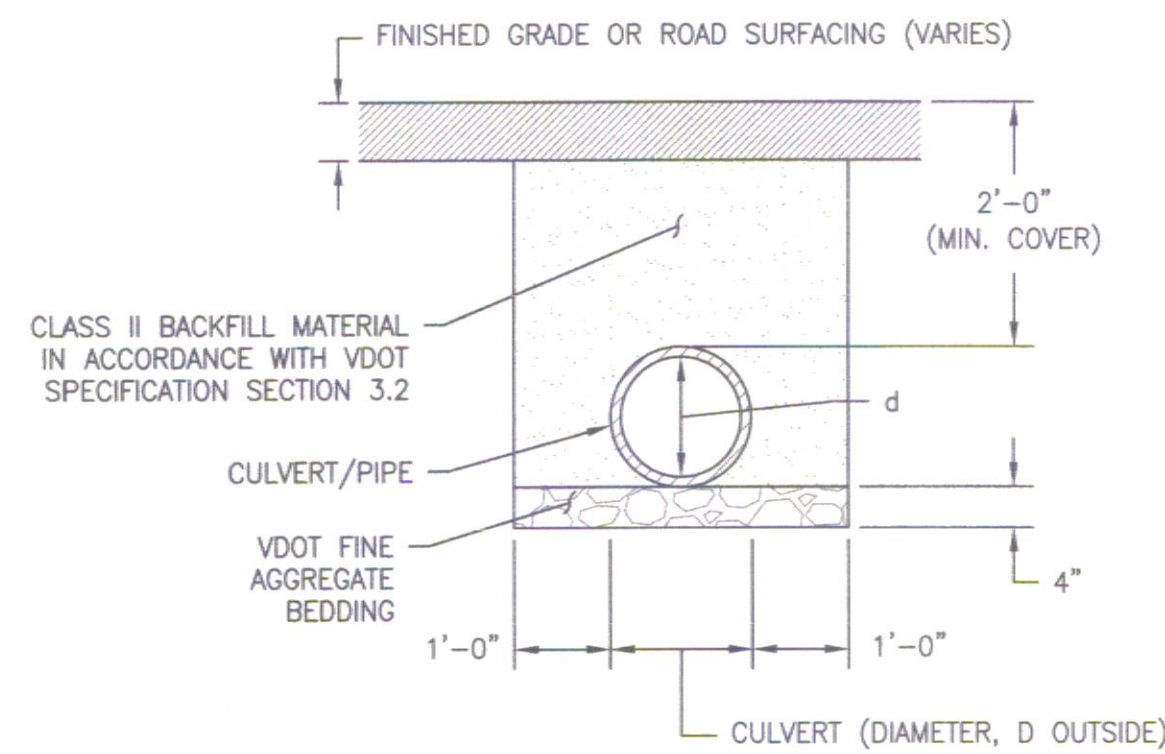


NOTES:

- 1' MINIMUM CLEARANCE BETWEEN MULTIPLE CULVERTS AND BETWEEN PIPE AND EDGE OF TRENCH.
- ROAD SURFACING MATERIAL SHALL MEET PROJECT SPECIFICATIONS.
- REFERENCES TO VDOT SPECIFICATIONS SHALL BE TO THE LATEST EDITION OF THE VDOT ROAD AND BRIDGE SPECIFICATIONS.

TYPICAL PLASTIC/HDPE CULVERT AND PIPE TRENCH 4/4,9
N.T.S.

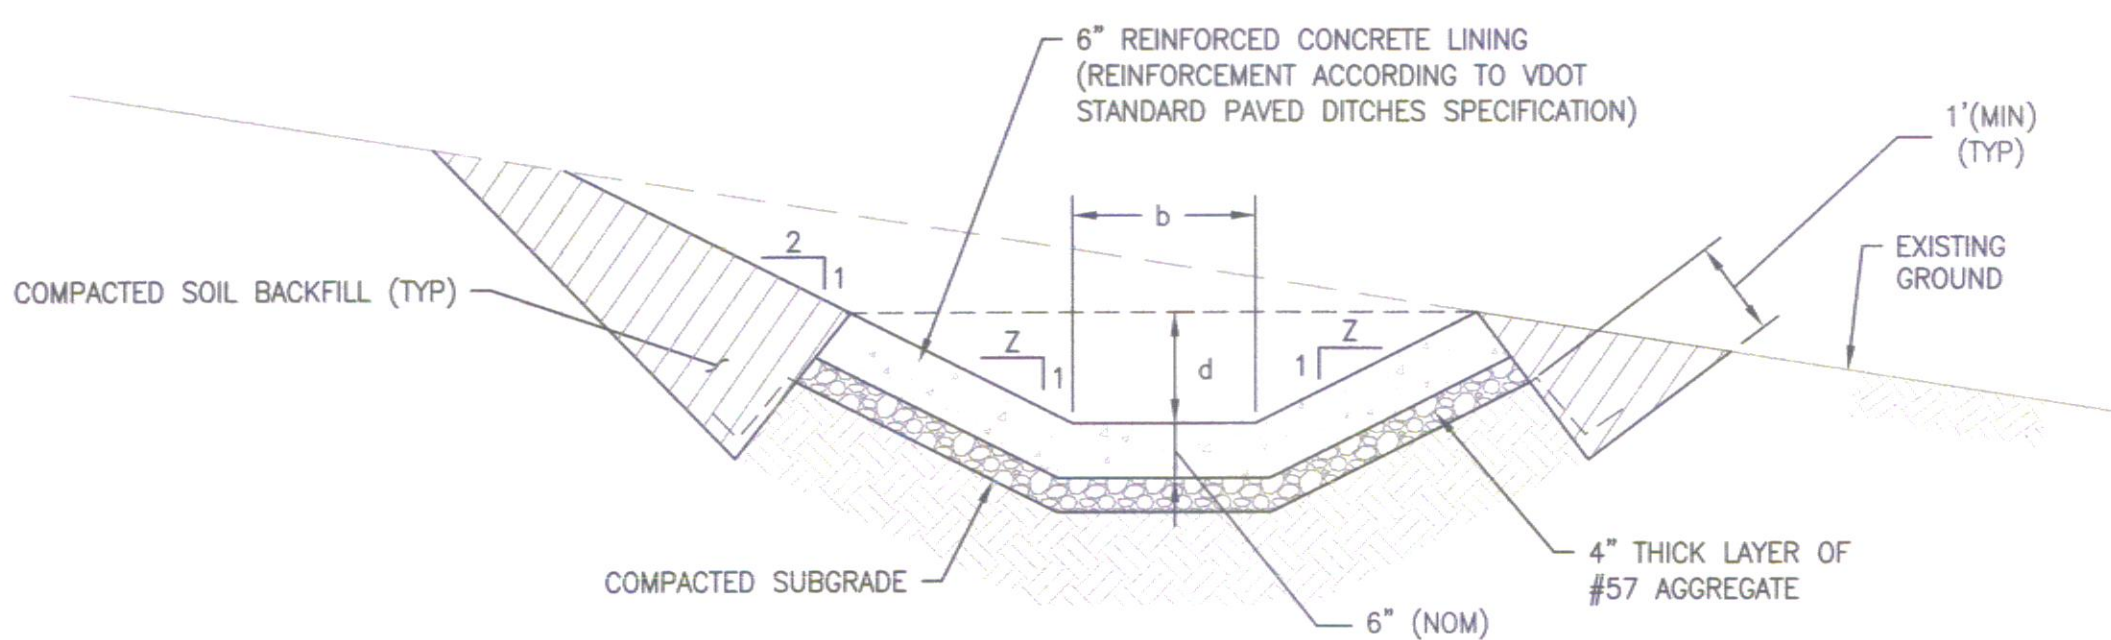


CONCRETE CHANNEL 6/10
N.T.S.

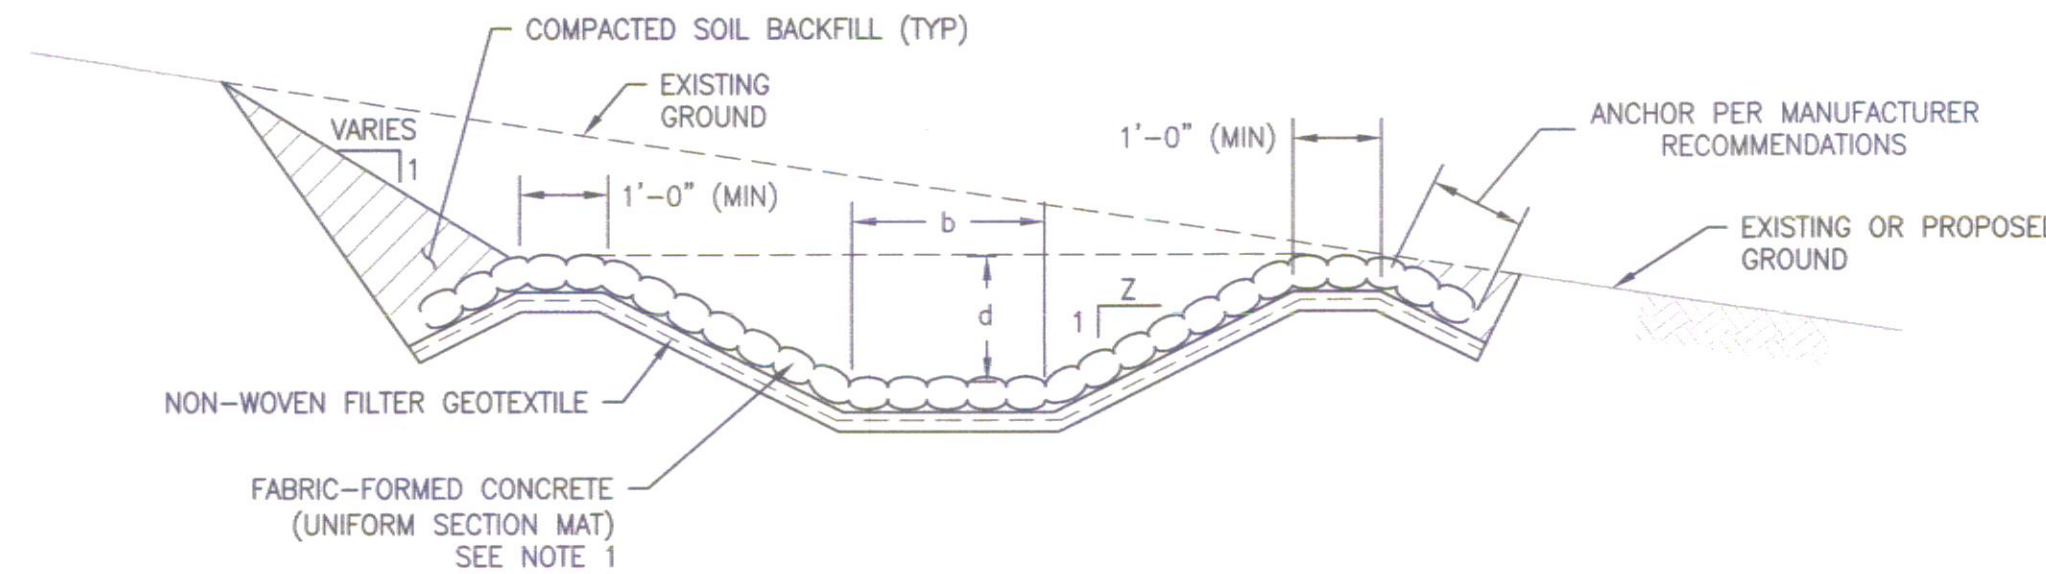

NOTE:

- A CONCRETE CHANNEL MAY BE SUBSTITUTED FOR THE FABRIC-FORMED CONCRETE CHANNEL. SEE DETAIL 6/10.


FABRIC-FORMED CONCRETE CHANNEL 2/4,5,10
N.T.S.

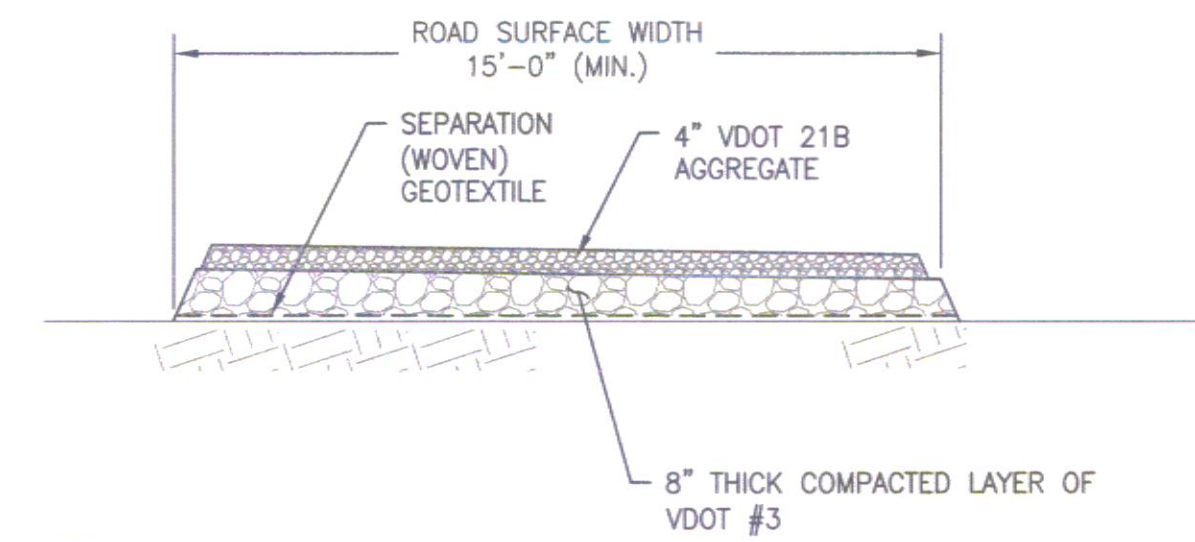


NOTE:

- IF EXISTING ROAD MATERIAL ON AN AREA NOT RECEIVING CAP CONTAINS CCRS, REMOVE MATERIAL AND DISPOSE OF AS DIRECTED.

ROADS 3/4,9
N.T.S.

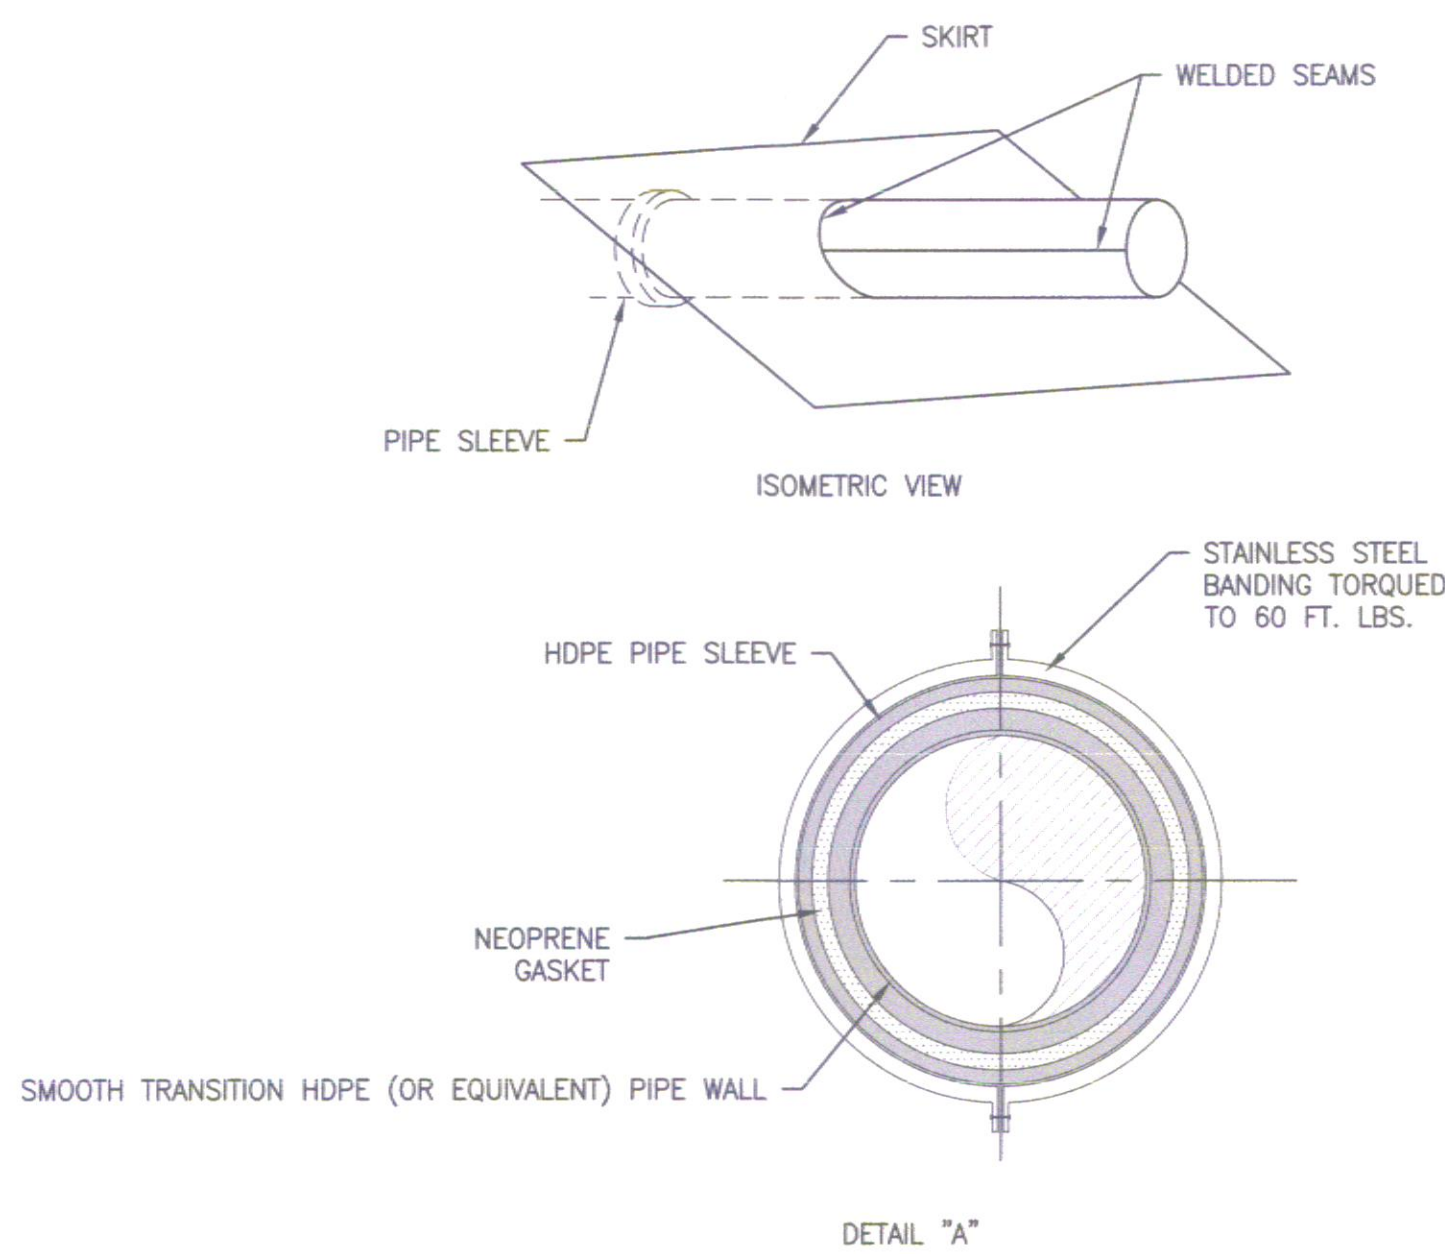


DETAIL "A"

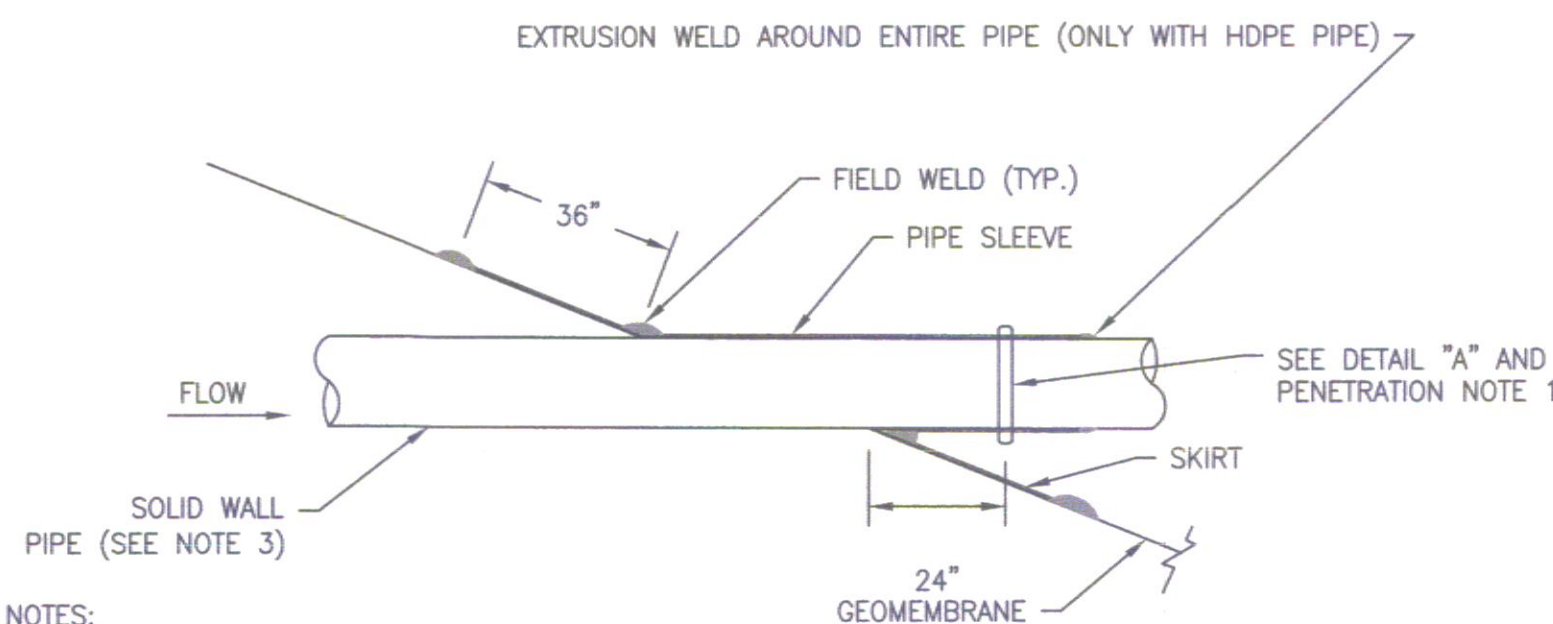

PENETRATION NOTES:

- USE ONE STAINLESS STEEL BAND PER PIPE PENETRATION SEAL.
- SKIRT IS TO EXTEND 36 INCHES BEYOND PIPE IN ALL DIRECTIONS.
- ADD N-12 PIPE WILL CONNECT WITH A SMOOTH WALL HDPE PIPE FOR FIELD WELD OF LINER TO PIPE SLEEVE. CONNECTION SHALL BE MADE WITH A FERNCO COUPLING OR APPROVED EQUIVALENT.

PIPE PENETRATION SEAL 5/10
N.T.S.

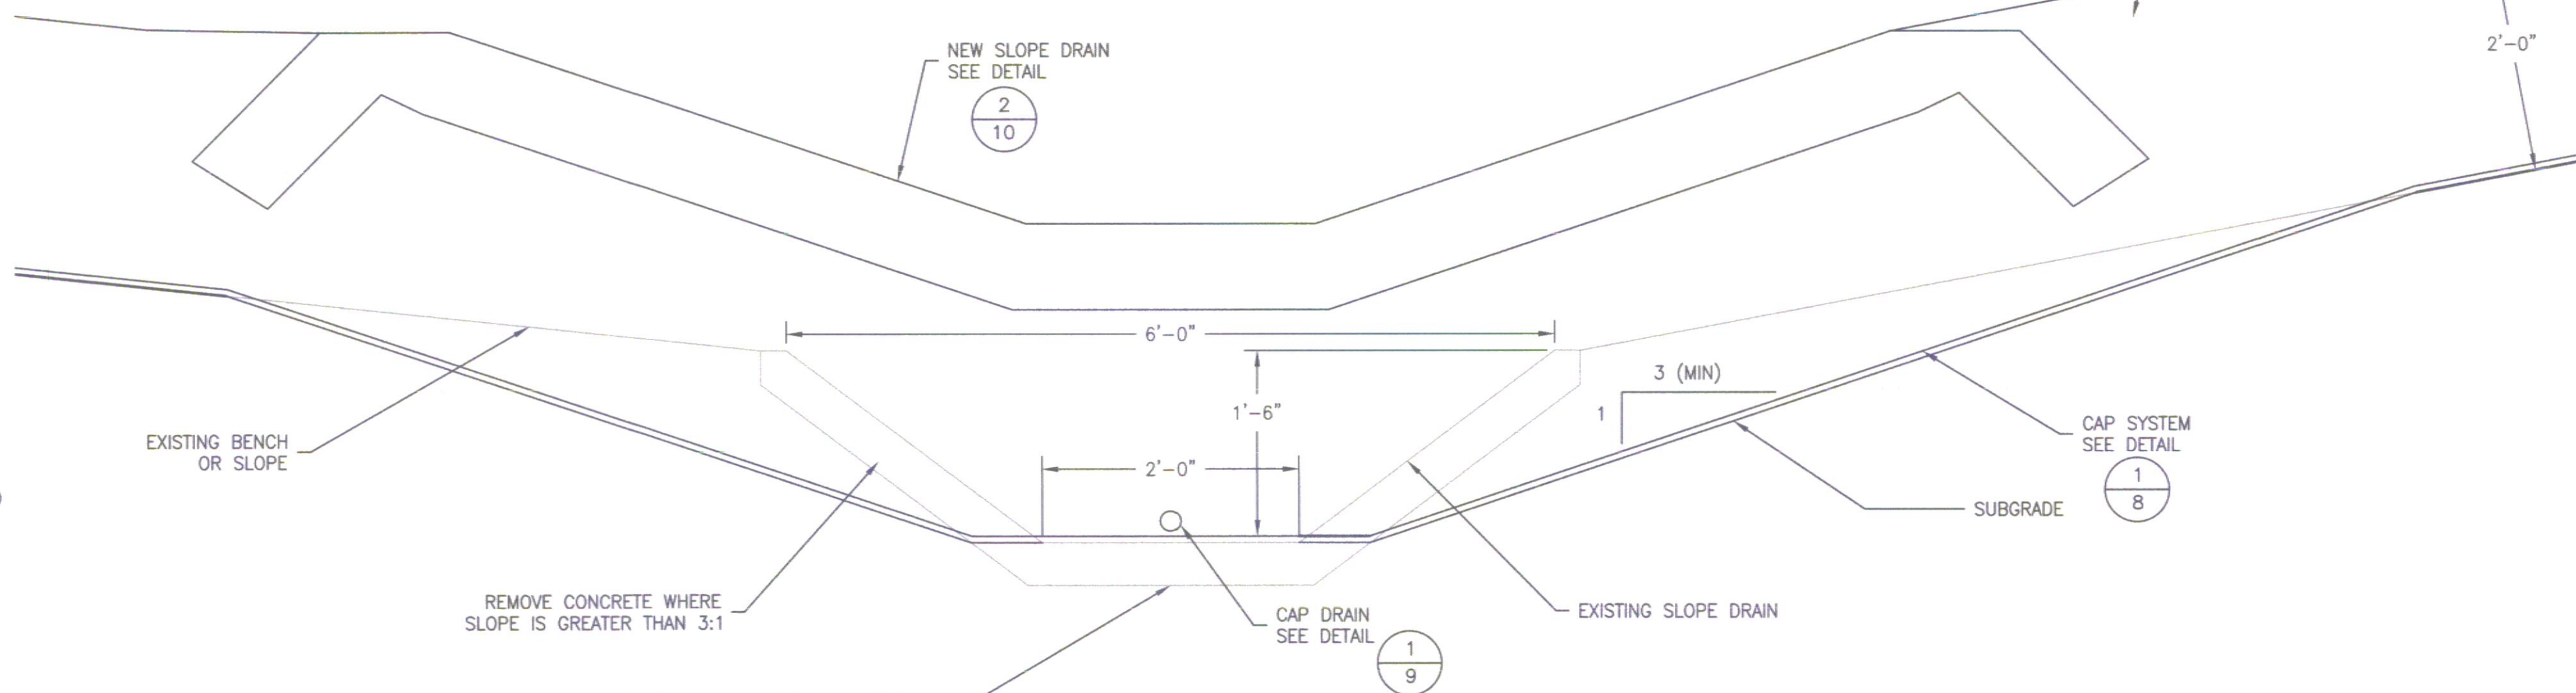

SLOPE DRAIN DETAIL 7/4
N.T.S.

NOTES:

- SLOPE DRAIN ENERGY DISSIPATOR IS TO BE INSTALLED AT THE TOE OF EACH SLOPE DRAIN, PRIOR TO DISCHARGING INTO THE PERIMETER CHANNEL.
- SLOPE DRAINS TO BE INSTALLED AT LOCATIONS WHERE THERE IS NO EXISTING SLOPE DRAIN WILL BE INSTALLED AS PER DETAIL 2/10.
- THE CAP SYSTEM AND FINAL COVER SHALL BE COLLECTIVELY REFERRED TO AS THE ENGINEERED COVER SYSTEM.

					DESCRIPTION:
A	1/7/2016	WJH	KMB	JDP	
NO.:	DATE:	DWN:	CHK:	APV:	
REVISION RECORD					

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DRAWING TITLE		
DRAINAGE AND MISCELLANEOUS DETAILS		
PROJECT		CLIENT
UPPER (EAST) POND CCR CLOSURE CHESTERFIELD POWER STATION CHESTERFIELD COUNTY, VIRGINIA		DOMINION GLEN ALLEN, VIRGINIA
ISSUING OFFICE: Pittsburgh 385 E. Waterfront Drive, Homestead, PA 15120		

DRAWN BY:	CHECKED BY:	APPROVED BY:	GAI FILE NUMBER:
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DWG TYPE:	SCALE:	ISSUE DATE:	ALT./CLIENT DRAWING NUMBER:
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REVISION	SHEET NO.:	GAI DRAWING NUMBER:	
A	10 OF 10	C150035-00-000-00-C-E1-110	